


LOCATION PLAN SCALE: $1" = 2,000' \pm$

WILDLIFE PROTECTION NOTES (ENV-WQ 1504.17)

- ALL DISSERVATIONS OF THREATENED OR ENDANGERED SPECIES SHALL BE REPORTED IMMEDIATELY TO THE NEW HAMPSHIRE FISH AND GAME DEPARTMENT NONCAME AND ENANGERED WILLDLIFE ENVIRONMENTAL REVIEW PROGRAM BY PHONE AT 50-227-2481 AND BY SHALL AT HAMPGREVIEW BY MICHELIFE INLSCY. ENALL SUSJECT LINE:
- PROCRAM BY PHONE AT GOL-271-261 AND BY EMAIL AT NHFGREVIEWSWILDLIFE.NHLGOV, EMAIL SUBJECT LINE: NHB2-1075, IMPNESSTOWN MANOR, WILDLIFE SPECIES DESERVATION, PHOTOGRAPHS OF THE OBSERVED SPECIES AND NEARBY ELEMENTS OF HABITATOR AREAS OF LAND IDSTURBANCE SHALL BE PROVIDED TO NHFGE IN DIGTAL FORMAT FOR VERIFICATION AS FEASIBLE; IN THE EYENT A THREATENED OR ENDANGERED SPECIES IS OBSERVED ON THE PROJECT SITE DURING THE TERM OF THE EYENT A THREATENED OR ENDANGERED SPECIES IS OBSERVED ON THE PROJECT SITE DURING THE TERM OF THE STATE OF THE S

RESIDENTIAL SITE PLAN JENNESSTOWN MANOR MAP 7; LOTS 39 & 39-1 ROUTE 103 WARNER, NEW HAMPSHIRE



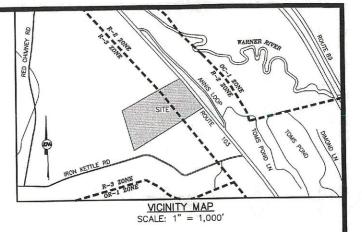

CARY FITZGERALD, MEMBE

LEDGE AND ROCK REMOVAL

PEACOCK HILL ROAD, LIC CERTIFIES THAT THE INTENT IS THAT ALL LEDGE AND ROCK
REMOVAL WILL BE CONDUCTED BY MECHANICAL MEANS. SHOULD SITE CONDITIONS
DETERMINE SITE OF LESS THAN \$,000 CY IS REQUIRED, PEACOCK HILL ROAD, LIC
CERTIFIES BLAST MEETS THAN \$,000 CY IS REQUIRED, PEACOCK HILL ROAD, LIC
CERTIFIES BLAST MEETS THAN ANAGEMENT PEACTICES QUILLIBED IN ENVIYOR 1510 WILL
PEACON OF BLAST HIS IN EXCESS OF \$,000 CY IS PERMITTED WITHOUT CONTACTING
THE DESIGN REMINIER AND HINDES ALTERATION OF TERRAIN

LEGEND TREE WETLANDS OPEN AREA & LANDSCAPE BUILDINGS LOT BOUNDARY SEPTIC

WELL RADIUS

OWNER/APPLICANT: PEACOCK HILL ROAD, LLC 145 OLD TOWN ROAD WEARE, NH 03281

ENGINEER:

KEACH-NORDSTROM ASSOCIATES, INC. 10 COMMERCE PARK NORTH, SUITE 3B BEDFORD, NEW HAMPSHIRE 03110 (603) 627-2881

SURVEYOR:

J.E. BELANGER LAND SURVEYING PLLC 61 OLD HOPKINTON ROAD DUNBARTON, NEW HAMPSHIRE 03046 (603) 774-3601

SCALE: 1" = 40"









KEACH-NORDSTROM ASSOCIATES, INC. Civil Engineering Land Surveying Landscape Architecture namerce Park North, Suite 3B, Bedford, NH 03110 Phone (803) 627-2881

MARCH 25, 2024 REVISED MAY 22, 2025 PROJECT NO. 24-0307-1

SHEET No. SHEET TITLE 1 - 2EXISTING CONDITIONS PLAN 3 SITE PLAN EASEMENT PLAN GRADING, DRAINAGE & UTILITY PLAN EROSION CONTROL PLAN LANDSCAPE PLAN LIGHTING PLAN SITE VISIBILITY FROM ROAD PLAN & PROFILE 10 SIGHT DISTANCE PLAN 11 DRIVEWAY PROFILE PLAN 12 - 16CONSTRUCTION DETAILS A1 - A5ARCHITECTURAL DRAWINGS

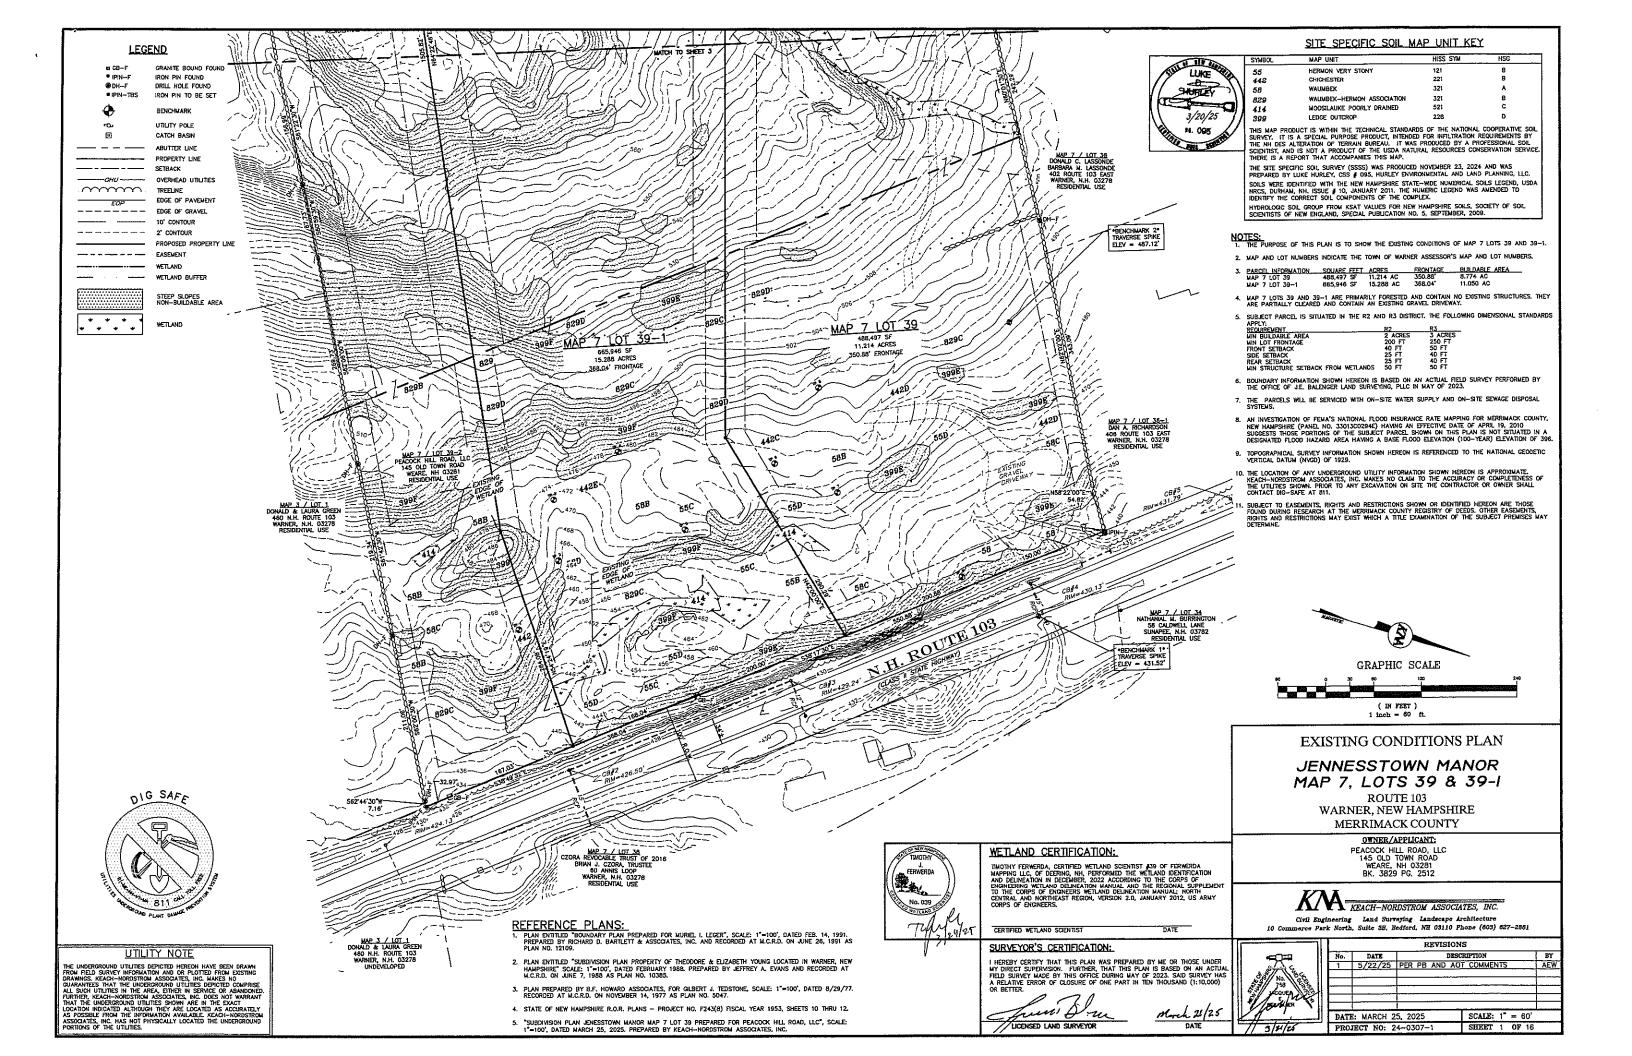

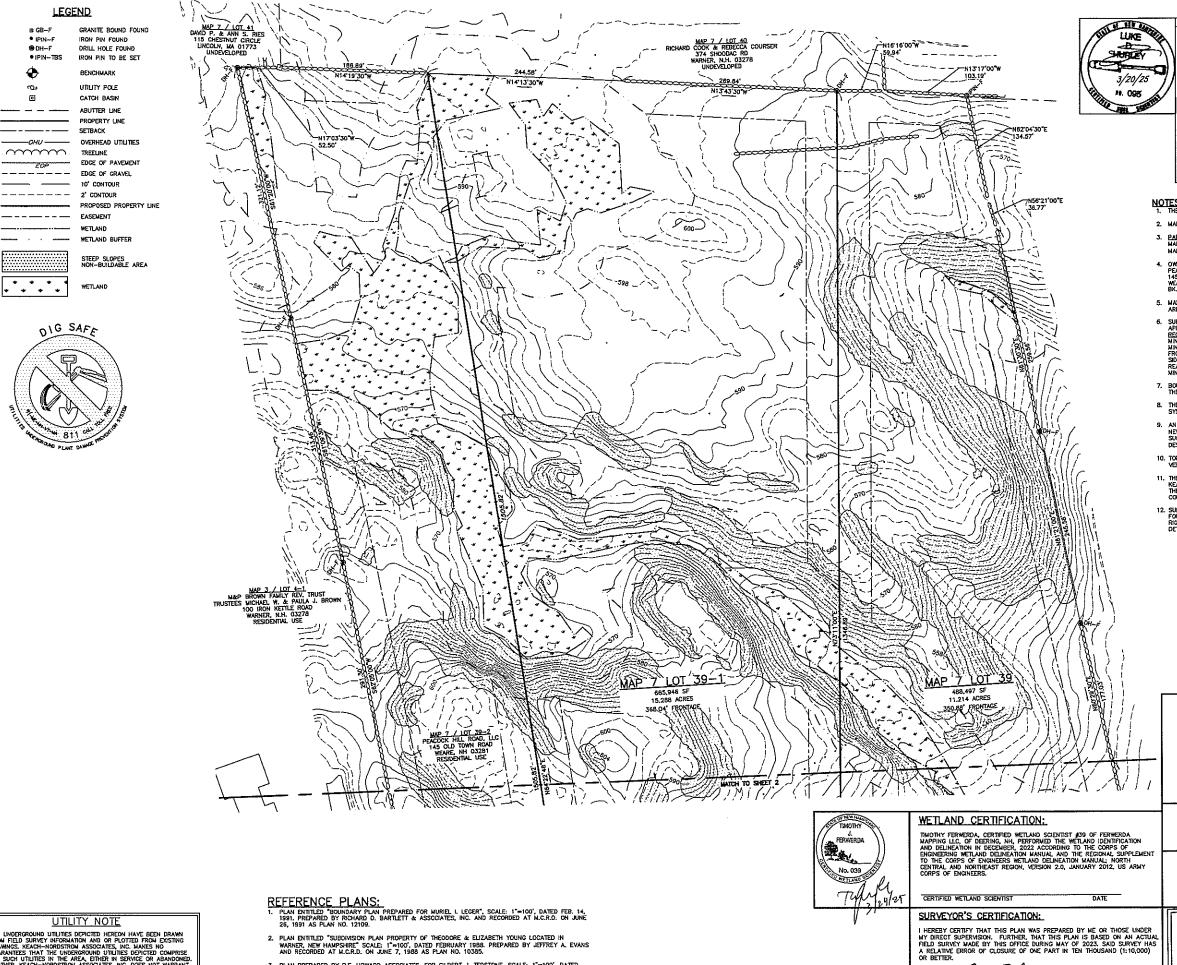

SITE SPECIFIC SOIL MAP UNIT KEY

MAP UNIT HERMON VERY STONY CHICHESTER WAUMBEK WAUMBEK-HERMON ASSOCIATION MOOSILAUKE POORLY DRAINED 521 LEDGE OUTCROP 228

THIS MAP PRODUCT IS WITHIN THE TECHNICAL STANDARDS OF THE NATIONAL COOPERATIVE SOIL SURVEY. IT IS A SPECIAL PURPOSE PRODUCT, INTENDED FOR INFILTRATION REQUIREMENTS BY THE NH DES ALTERATION OF TERRIN BUREAU, IT WAS PRODUCED BY A PROFESSIONAL SOIL SCIENTIST, AND IS NOT A PRODUCT OF THE USDA NATURAL RESOURCES CONSERVATION SERVICE. THERE IS A REPORT THAT ACCOMPANIES THIS MAP.

THE SITE SPECIAL SOIL SURVEY (SSSS) WAS PRODUCED NOVEMBER 23, 2024 AND WAS PREPARED BY LUKE HURLEY, CSS # 095, HURLEY ENVIRONMENTAL AND LAND PLANNING, LLC. SOILS WERE IDENTIFIED WITH THE NEW HAMPSHER STATE—MOR NUMERICAL SOILS LECEND, USDA NRCS, DURNAM, NH. ISSUE # 10, JANUARY 2011, THE NUMERIC LECEND WAS AMENDED TO IDENTIFY THE CORRECT SOIL COMPONENTS OF THE COMPLEX.

HYDROLOGIC SOIL GROUP FROM KSAT VALUES FOR NEW HAMPSHIRE SOILS, SOCIETY OF SOIL SCIENTISTS OF NEW ENGLAND, SPECIAL PUBLICATION NO. 5, SEPTEMBER, 2009.

NOTES:
1. THE PURPOSE OF THIS PLAN IS TO SHOW THE EXISTING CONDITIONS OF MAP 7 LOTS 39 AND 39-1.


- 2. MAP AND LOT NUMBERS INDICATE THE TOWN OF WARNER ASSESSOR'S MAP AND LOT NUMBERS.
- S. PARCEL INFORMATION
 SQUARE_FEET_AGRES
 FRONTAGE
 BUILDABLE_AREA

 MAP 7 LOT 39
 488,497 SF
 11.214 AC
 350.88'
 8.774 AC

 MAP 7 LOT 39-1
 665,946 SF
 15,288 AC
 368.04'
 11.050 AC
- 4. OWNER OF RECORD: PEACOCK HILL ROAD, LLC 145 OLD TOWN ROAD WEARE, NH 03281 BK, 3829 PG, 2512
- MAP 7 LOTS 39 AND 39-1 ARE PRIMARILY FORESTED AND CONTAIN NO EXISTING STRUCTURES. THEY
 ARE PARTIALLY CLEARED AND CONTAIN AN EXISTING GRAVEL DRIVEWAY.
- 6. SUBJECT PARCEL IS SITUATED IN THE R2 AND R3 DISTRICT. THE FOLLOWING DIMENSIONAL STANDARDS

RECORDENIE		
MIN BUILDABLE AREA	2 ACRES	3 ACRES
MIN LOT FRONTAGE	200 FT	250 FT
FRONT SETBACK	40 FT	50 FT
SIDE SETBACK	25 FT	40 FT
REAR SETBACK	25 FT	40 FT
MIN STRUCTURE SETBACK FROM WETLANDS	50 FT	50 FT

- BOUNDARY INFORMATION SHOWN HEREON IS BASED ON AN ACTUAL FIELD SURVEY PERFORMED BY THE OFFICE OF J.E. BALENGER LAND SURVEYING, PLLC IN MAY OF 2023.
- THE PARCELS WILL BE SERVICED WITH ON-SITE WATER SUPPLY AND ON-SITE SEWAGE DISPOSAL SYSTEMS.
- 9, AN INVESTIGATION OF FENA'S NATIONAL FLOOD INSURANCE RATE MAPPING FOR MERRIMACK COUNTY, NEW HAMPSHIRE (PANEL NO. 33013C0294E) HAWNG AN EFFECTIVE DATE OF APRIL 19, 2010 SUGGESTS THOSE PORTIONS OF THE SUBJECT PARCEL SHOWN ON THIS PLAN IS NOT SITUATED IN A DESIGNATED FLOOD HAZARD AREA HAVING A BASE FLOOD ELEVATION (100—YEAR) ELEVATION OF 396.
- Topographical survey information shown hereon is referenced to the national geodetic vertical datum (NYGO) of 1929.
- 11. THE LOCATION OF ANY UNDERGROUND UTILITY INFORMATION SHOWN HEREON IS APPROXIMATE. KEACH-NORDSTROM ASSOCIATES, INC. MAKES NO CLAIM TO THE ACCURACY OR COMPLETENESS OF THE UTILITIES SHOWN. PRIOR TO ANY EXCAVATION ON SITE THE CONTRACTOR OR OWNER SHALL CONTACT DIG-SAFE AT 811.
- 12. SUBJECT TO EASCHENTS, RIGHTS AND RESTRICTIONS SHOWN OR IDENTIFIED HEREON ARE THOSE FOUND DURING RESEARCH AT THE MERRIMACK COUNTY REGISTRY OF DEEDS. OTHER EASCHENTS, RIGHTS AND RESTRICTIONS MAY EXIST WHICH A TITLE EXAMINATION OF THE SUBJECT PREMISES MAY DETERMINE.

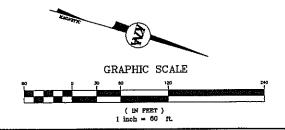

EXISTING CONDITIONS PLAN

JENNESSTOWN MANOR MAP 7, LOTS 39 & 39-1

ROUTE 103

WARNER, NEW HAMPSHIRE MERRIMACK COUNTY

OWNER/APPLICANT:

PEACOCK HILL ROAD, LLC 145 OLD TOWN ROAD WEARE, NH 03281 BK, 3829 PG, 2512



KEACH-NORDSTROM ASSOCIATES, INC.

Civil Engineering Land Surveying Landscape Architecture 10 Commerce Park North, Suite 3B, Bedford, NH 03110 Phone (603) 627-2881

Juni Dom

LICENSED LAND SURVEYOR


March 21/25


		REVISIO	MS	
No.	DATE		SCRIPTION	BY
1	5/22/25	PER PB AND A	OT COMMENTS	ΑE

DATE	: MARCH 2	5, 2025	SCALE: 1" = 60'	
PRO	ECT NO: 2	4-0307-1	SHEET 2 OF 16	

THE UNDERGROUND UTILITIES DEPICTED HEREON HAVE BEEN DRAWN FROM FELD SURVEY INFORMATION AND OR PLOTTED FROM EXISTING DRAWNES, KEACH-NORDSTROM ASSOCIATES, INC. MAKES NO CHARMATIES THAT THE UNDERGROUND UTILITIES DEPICTED COMPRISE ALL SUCH UTILITIES IN THE AREA, ETHER IN SERVICE OR ABANDONDE FURTHER, KEACH-NORDSTROM ASSOCIATES, INC. MOSE NOT WARRANT THAT THE UNDERGROUND UTILITIES SHOWN ARE IN THE EXACT LICCATION INDICATED ALTHOUGH THEY ARE LOCATED AS ACCURATELY AS POSSIBLE FROM THE IMPORMATION AVAILABLE KEACH-NORDSTROM ASSOCIATES, INC. HAS NOT PHYSICALLY LOCATED THE UNDERGROUND PORTIONS OF THE UTILITIES.

- PLAN ENTITLED "SUBCIVISION PLAN PROPERTY OF THEODORE & ELIZABETH YOUNG LOCATED IN WARNER, NEW HAMPSHIRE" SCALE: 1"=100", DATED FEBRUARY 1988. PREPARED BY JEFFREY A. EVANS AND RECORDED AT M.C.R.D. ON JUNE 7, 1988 AS PLAN NO. 10385.
- PLAN PREPARED BY B.F. HOWARD ASSOCIATES, FOR GLBERT J. TEDSTONE, SCALE: 1°=100°, DATED 8/29/77. RECORDED AT M.C.R.D. ON NOVEMBER 14, 1977 AS PLAN NO. 5047.
- 4. STATE OF NEW HAMPSHIRE R.O.R. PLANS PROJECT NO. F243(8) FISCAL YEAR 1953, SHEETS 10 THRU 12.

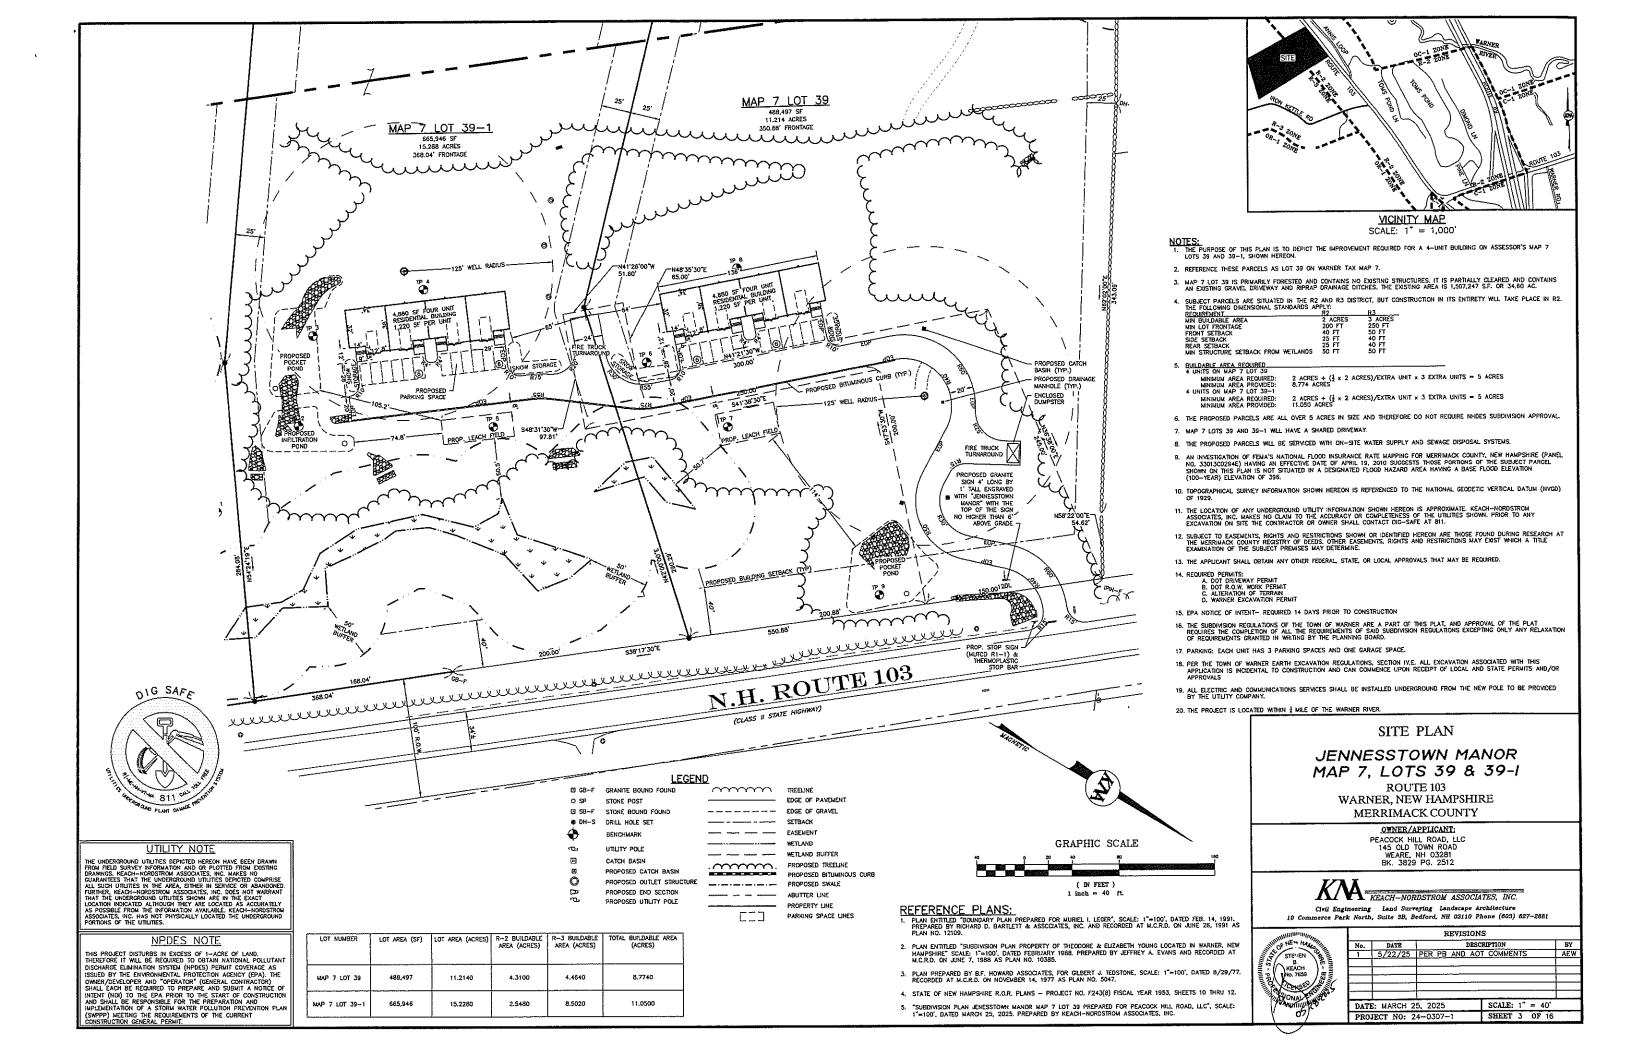

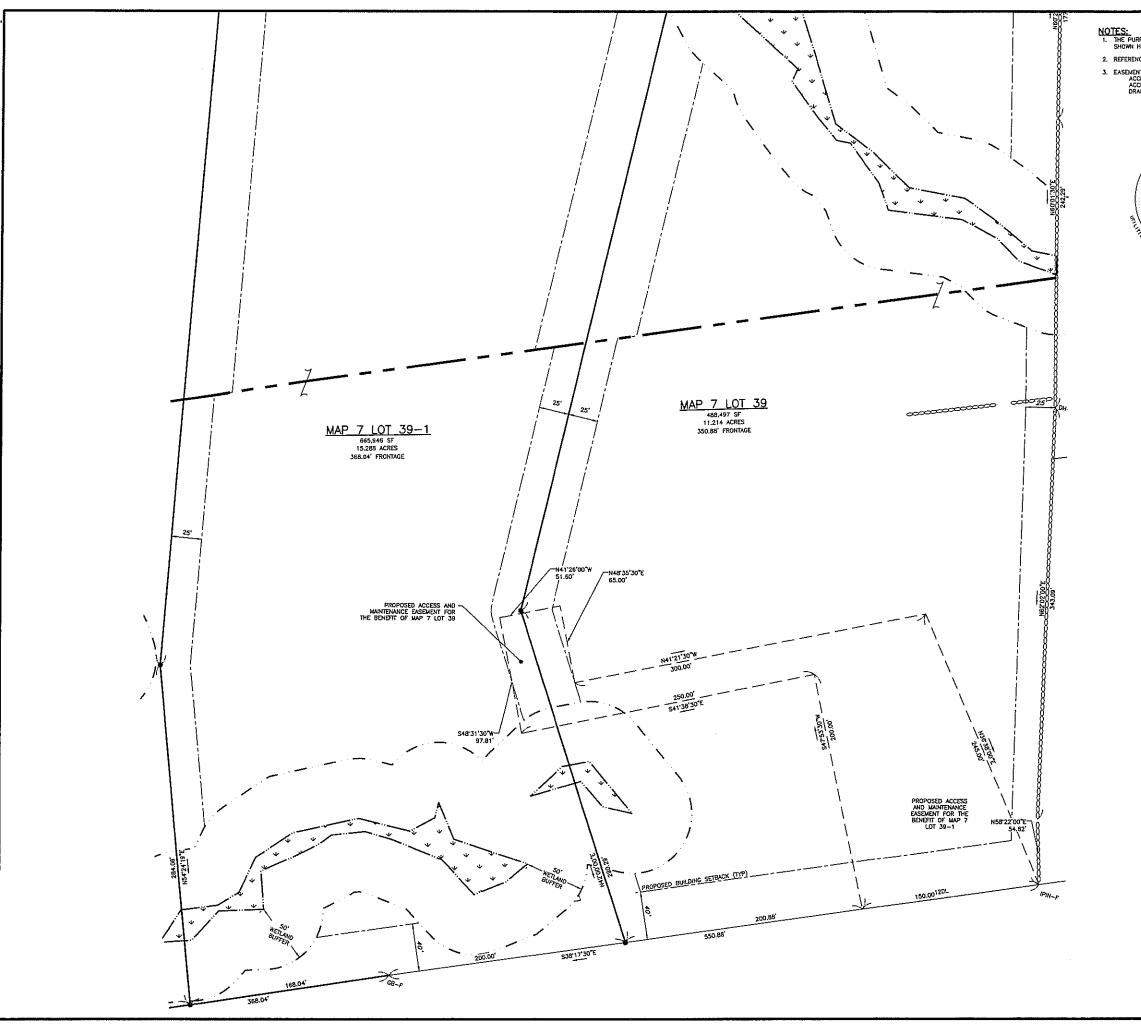

NOTES: 1. THE PURPOSE OF THIS PLAN IS TO DEPICT THE PROPOSED EASEMENTS ON ASSESSOR'S MAP 7 LOTS 39 AND 39-1, SHOWN HEREON.

2. REFERENCE THESE PARCELS AS LOT 39 ON WARNER TAX MAP 7.

3. EASEMENTS:

ACCESS AND MAINTENANCE EASEMENT — ON MAP 7 LOT 39 TO BENEFIT MAP 7 LOT 39-1

ACCESS AND MAINTENANCE EASEMENT — ON MAP 7 LOT 39-1 TO BENEFIT MAP 7 LOT 39

DRAINAGE EASEMENT — GENERAL DRAINAGE EASEMENT ON MAP 7 LOTS 39 AND 39-1 FOR MUTUAL BENEFIT




LEGEND

@ GB-F CRANITE BOUND FOUND # SB-F STONE BOUND FOUND OH-S DRILL HOLE SET ---- ABUTTER LINE PROPERTY LINE --- SETBACK - EASEMENT WETLAND --- --- WETLAND BUFFER

- REFERENCE PLANS:

 1. PLAN ENTITLED "BOUNDARY PLAN PREPARED FOR MURIEL I. LEGER", SCALE: 1"-100", DATED FEB. 14, 1991, PREPARED BY RICHARD D. BARTLETT & ASSOCIATES, INC. AND RECORDED AT M.C.R.D. ON JUNE 26, 1991 AS PLAN NO. 12109.
- PLAN ENTITLED "SUBDIMISION PLAN PROPERTY OF THEODORE & ELIZABETH YOUNG LOCATED IN WARNER, NEW HAMPSHIRE" SCALE: 1"=100", DATED FEBRUARY 1988, PREPARED BY JEFFREY A. EVANS AND RECORDED AT M.C.R.D. ON JUNE 7, 1988 AS PLAN NO. 10385.
- PLAN PREPARED BY B.F. HOWARD ASSOCIATES, FOR GLBERT J. TEDSTONE, SCALE: 1**100°, DATED 8/29/77. RECORDED AT M.C.R.D. ON NOVEMBER 14, 1977 AS PLAN NO. 5047.
- 4. STATE OF NEW HAMPSHIRE R.O.R. PLANS -- PROJECT NO. F243(8) FISCAL YEAR 1953, SHEETS 10 THRU 12.
- 5. "Subdivision plan Jenesstown Manor Map 7 Lot 39 prepared for Peacock Hill Road, Ilc", scale: 1"=100", dated March 25, 2025. Prepared by Keach-Nordstrom Associates, Inc.

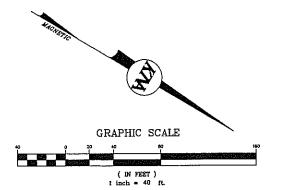

EASEMENT PLAN

JENNESSTOWN MANOR MAP 7, LOTS 39 & 39-1

ROUTE 103 WARNER, NEW HAMPSHIRE MERRIMACK COUNTY

OWNER/APPLICANT:


PEACOCK HILL ROAD, LLC 145 OLD TOWN ROAD WEARE, NH 03281 BK, 3829 PG, 2512




KA REACH-NORDSTROM ASSOCIATES, INC.

Civil Engineering Land Surveying Landscape Architecture 10 Commerce Park North, Suite 3B, Bedford, NH 03110 Phone (603) 827-2881

	1		REVISION	ıs	
	No.	DATE		CRIPTION	BY
677715	1	5/22/25	PER PB AND AO	T COMMENTS	ΑE
1 35 m			 		
ACOUEA 3					
Jest 10					
	DATI	E: MARCH 2	25, 2025	SCALE: 1" = 40'	
3/21/26	PRO.	JECT NO: 2	24-0307-1	SHEET 4 OF 16	

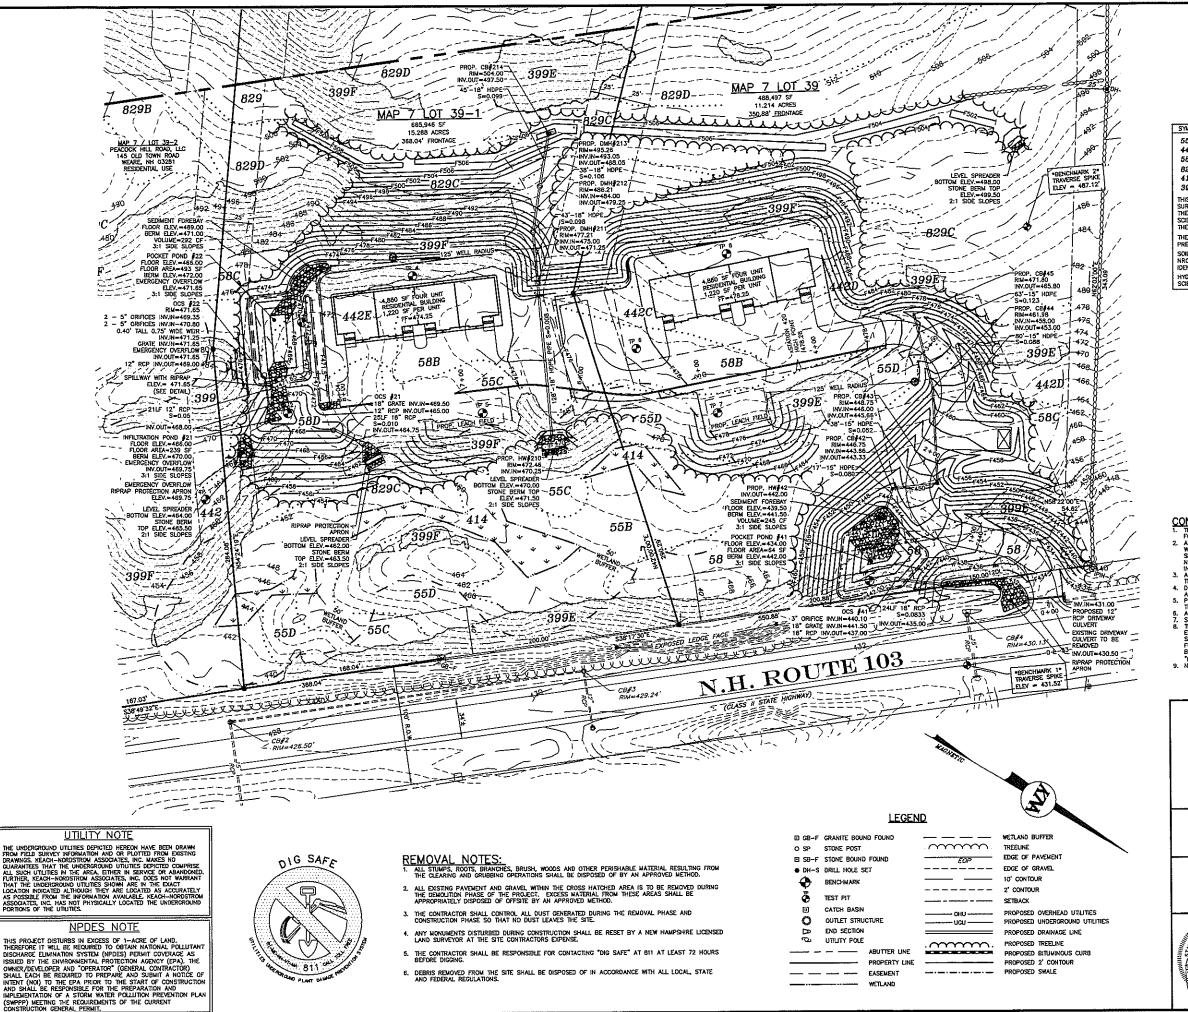

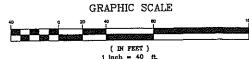

SITE SPECIFIC SOIL MAP UNIT KEY

MAP UNIT	HISS SYM	HSG
HERMON VERY STONY	121	9
CHICHESTER	221	В
WAUMBEK	321	A
WAUMBEK-HERMON ASSOCIATION	321	В
MOOSILAUKE POORLY DRAINED	521	C
LEDGE OUTCROP	225	Ð
	HERMON VERY STONY CHICHESTER WAUMBEK WAUMBEK-HERMON ASSOCIATION MOOSILAUKE POORLY DRAINED	HERMON VERY STONY

THIS MAP PRODUCT IS WITHIN THE TECHNICAL STANDARDS OF THE NATIONAL COOPERATIVE SOIL SURVEY, IT IS A SPECIAL PURPOSE PRODUCT, INTENDED FOR INFILITATION REQUIREMENTS BY THE MH DES ALTERATION OF TERRAIN BUREAU, IT WAS PRODUCED BY A PROFESSIONAL SOIL SCIENTIST, AND IS NOT A PRODUCT OF THE USDA NATURAL RESOURCES CONSERVATION SERVICE. THERE IS A REPORT THAT ACCOMPANIES THIS MAP.

THER IS A REPORT THAT ACCOMPANIES INIS MAP.

THE STEE SPECIFIC SOIL, SURVEY (SSSS) WAS PRODUCED NOVEMBER 23, 2024 AND WAS PREPARED BY LUKE HUNLEY, CSS § 095, HURLEY ENVIRONMENTAL AND LAND PLANNING, LLC.

SOILS WERE IDENTIFED WITH THE NEW HAMPSHIRE STATE-MOR NUMERICAL SOILS LEGEND, USDA NRCS, DURHAM, NIH. ISSUE § 10, JANIARY 2011. THE NUMERICAL EGEND WAS AMENDED TO IDENTIFY THE CORRECT SOIL COMPONENTS OF THE COMPLEX.

HYDROLOGIC SOIL GROUP FROM KSAT VALUES FOR NEW HAMPSHIRE SOILS, SOCIETY OF SOIL SCIENTISTS OF NEW ENGLAND, SPECIAL PUBLICATION NO. 5, SEPTEMBER, 2009.



LOAM & SEED ALL DISTURBED AREAS (TYP.)

- CONSTRUCTION NOTES:

 1. THE PURPOSE OF THIS PLAN IS TO SHOW THE PROPOSED GRADING, DRAINAGE AND UTILITY SYSTEMS FOR THIS SITE.

 2. ALL WORK SHALL CONFORM TO THE APPLICABLE REGULATIONS AND STANDARDS OF THE TOWN OF WARNER, AND SHALL BE BUILT IN A WORKMANLIKE MANNER IN ACCORDANCE WITH THE PLANS AND SECRIFICATIONS. THE STANDARD SPECIFICATIONS FOR ROAD AND BRIDGE CONSTRUCTION, STATE OF NEW HAMPSHIRE, DEPARTMENT OF TRANSPORTATION, APPROVED AND ADOPTED 2016 ARE HEREBY INCORPORATED BY REFERENCE.

 3. ALL STUDYES, ROOTS, BRANCIES, BRUSH, WOODS AND OTHER PERISHABLE MATERIAL RESULTING FROM THE CLEARING AND GRUBBING OPERATIONS SHALL BE DISPOSED OF BY AN APPROVED METHOD.

 4. DEBRIS REMOVED FROM THE SITE SHALL BE DISPOSED OF IN ACCORDANCE WITH ALL LOCAL, STATE AND FEDERAL REGULATIONS.

 5. PARKING LOT CONSTRUCTION SHALL CONFORN TO THE TYPICAL SECTIONS AND DETAILS SHOWN ON THE PLANS, AND SHALL MEET THE REQUIRCUENTS.

 6. ALL DISTURBED AREAS SHALL BE LOAMED AND SEEDED.

 7. SEE DETAILS FOR DRAINAGE SPECIFICATIONS.

 8. THE CONTRACTOR SHALL BE RESPONSIBLE FOR VEHICING AND DETERMINING THE LOCATION, SIZE AND ELEVATION OF ALL DISTING UTILITIES. SHOWN ON ON ON OTHER PRIVATE OF ANY CONSTRUCTION THE PLANS AND SHALL BE RESPONSIBLE FOR VEHICING HIND OF APPROVED TO THE START OF ANY CONSTRUCTION THE SESSION OF AND SHOWN ON THESE PLANS, PRIVATION THE STRONG WITH THE WORK. THE CONTRACTOR SHALL BE RESPONSIBLE FOR CONTRACTOR SHALL BE RESPONSIBLE.
- "DIG SAFE" AT 811 AT LEAST 72 HOURS BEFORE DIGGING.
 9. NO TEST BORINGS WERE COMPLETED OR PROVIDED.

GRADING, DRAINAGE, & UTILITIES PLAN

JENNESSTOWN MANOR MAP 7, LOTS 39 & 39-1

ROUTE 103 WARNER, NEW HAMPSHIRE MERRIMACK COUNTY

OWNER/APPLICANT:

PEACOCK HILL ROAD, LLC 145 OLD TOWN ROAD WEARE, NH 03281 BK. 3829 PG. 2512




KEACH-NORDSTROM ASSOCIATES, INC.

Civil Engineering Land Surreying Landscape Architecture merce Park North, Suite 3B, Bedford, NH 03110 Phone (603) 627-2881




			REVISIO	NS	
1	No.	DATE		CRIPTION	BY
	1	5/22/25	PER PB AND AC	OT COMMENTS	AEW
					-
	-				╁
		<u> </u>			
	DATI	E: MARCH 2	5, 2025	SCALE: 1" = 40"	
	PRO.	IECT NO: 2	4-0307-1	SHEET 5 OF 1	6

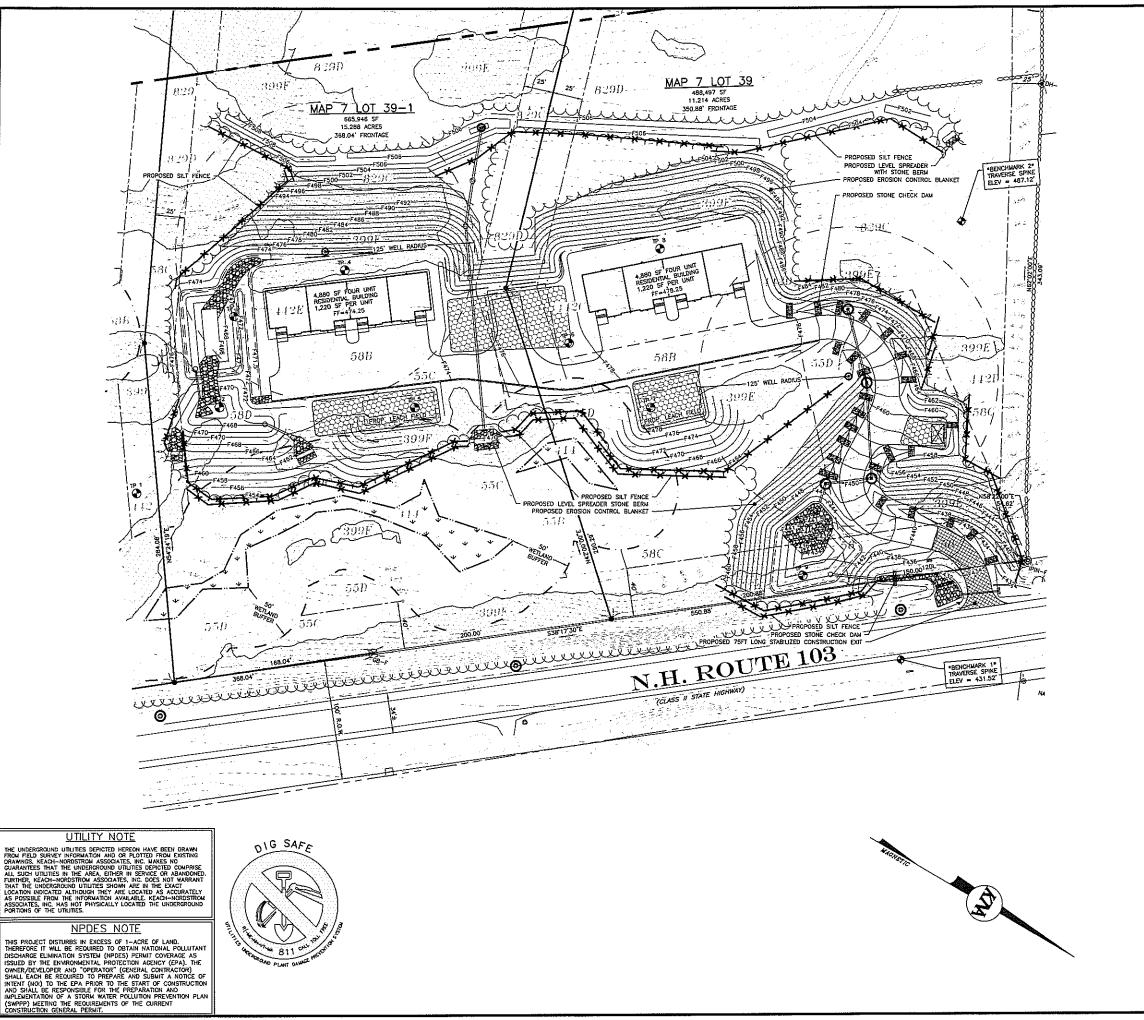



EDGE OF PAVEMENT IRON ROD FOUND @ iR-F — — EDGE OF GRAVEL @ RRSPK-F RAILROAD FOUND 10' CONTOUR DRILL HOLE FOUND _____ 2' CONTOUR COCCOCCOCCO STONEWALL UTILITY POLE SOIL UNE SPOT LIGHT ____ SETBACK ----- EASEMENT WELL H DOUBLE CATCH BASIN FLARED END SECTION al) ABUTTER LINE PROPERTY LINE ======= DRAINAGE LINE $\sim\sim\sim\sim$

> LOAM & SEED ALL DISTURBED AREAS (TYP.)

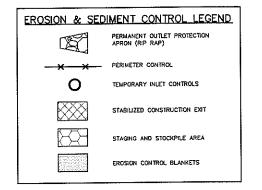

- EROSION CONTROL NOTES:

 1. THE PURPOSE OF THIS PLAN IS TO DEPICT THE REQUIRED ONSTE TEMPORARY CONSTRUCTION EROSION CONTROL MEASURES AS WELL AS THE PERMANENT EROSION CONTROL MEASURES AS WELL AS THE PERMANENT EROSION CONTROL MEASURES TO THE PERMANENT OF THE PROPERTY OF TH

- 4. APPROPRIATE EROSION AND SEDMENT CONTROL MEASURES SHALL BE INSTALLED PRICE TO JUST DISTURBANCE USING WILDLIFE FIREIDLY EROSION CONTROL MATERIALS TO PREVENT TRAPPING OF ANIMALS.

 5. THE AREA OF DISTURBANCE SHALL BE KEPT TO A MINIMUM. DISTURBED AREAS REMAINING IDLE FOR MORE THAN 5 DAYS SHALL BE STABILIZED.

 6. MEASURES SHALL BE TRAPPED AND RETAINED WITHIN THE PROJECT AREA. SEDMENT IN RUNOFF WATER SHALL BE TRAPPED AND RETAINED WITHIN THE PROJECT AREA USING APPROVED MEASURES.

 7. OFFSITE SURFACE WATER AND RUNOFF FROM UNDISTURBED AREAS SHALL BE UNETED AWAY FROM DISTURBED AREAS WHERE FEASIBLE OR COARRED NON-EROSIVELY THROUGH THE PROJECT AREA. INTEGRITY OF DOWNSTREAM DRAINAGE SYSTEMS SHALL BE MAINTAINED.

 8. ALL TEMPORARY EROSION AND SEDMENT CONTROL MEASURES SHALL BE MAINTAINED IN FUNCTIONING CONDITION UNIT. FINAL SITE STABILIZATION IS ACCOMPLISHED. SHALL BE MAINTAINED IN FUNCTIONING CONDITION UNIT. FINAL SITE STABILIZATION AND SEDMENT AND OTHER DISTURBED SOIL AREAS RESULTING FROM THE REMOVED. FERRE SHALL BE PROVING AFTER FINAL SITE STABILIZATION. TRAPPED SEDMENT AND OTHER DISTURBED SOIL AREAS RESULTING FROM THE REMOVED. OTHER FINAL SITE STABILIZATION. TRAPPED SEDMENT AND OTHER DISTURBED SOIL AREAS RESULTING FROM THE REMOVED. OTHER SHALL SERVE THE RIGHT TO RECOURE FURTHER EROSION CONTROL PRACTICES DILARIC OTHER SHALL SERVE THE RIGHT TO RECOURE FURTHER EROSION CONTROL PRACTICES DILARIC STRUCTURE SHALL DESERVE THE RIGHT TO RECOURE FURTHER EROSION CONTROL PRACTICES DILARIC STRUCTURE SHALL DESERVE THE RIGHT TO RECOURE FURTHER EROSION CONTROL PRACTICES DILARIC STRUCTURE SHALL DESERVE THE RIGHT TO RECOURE FURTHER EROSION CONTROL PRACTICES DILARIC STRUCTURE SHALL DESERVE THE RIGHT TO RECOURE FURTHER EROSION CONTROL PRACTICES DILARIC STRUCTURE SHALL DESERVE THE RIGHT TO RECOURE FURTHER EROSION CONTROL PRACTICES DILARIC STRUCTURE SHALL DILARIC SHALL SHAL

EROSION CONTROL PLAN

JENNESSTOWN MANOR MAP 7, LOTS 39 & 39-1


ROUTE 103 WARNER, NEW HAMPSHIRE MERRIMACK COUNTY


> OWNER/APPLICANT: PEACOCK HILL ROAD, LLC 145 OLD TOWN ROAD WEARE, NH 03281 BK. 3829 PG. 2512



KEACH-NORDSTROM ASSOCIATES, INC.

Civil Engineering Land Surveying Landscape Architecture 10 Commerce Park North, Suite 3B, Bedford, NH 03110 Phone (603) 627-2861

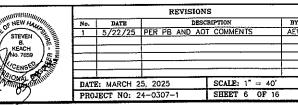

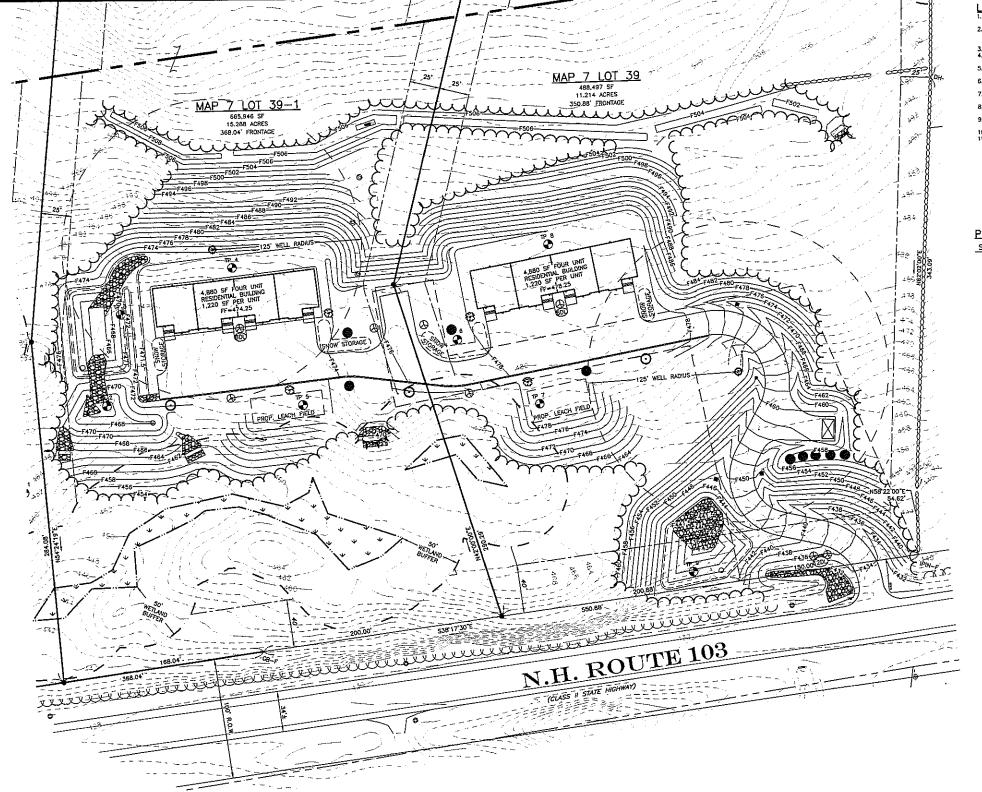

UTILITY NOTE

THE UNDERGROUND UTLINES DEPICTED HEREON HAVE BEEN DRAWN FROM FIELD SURVEY INFORMATION AND OR PLOTTED FROM EXISTING ORAMINGS. KEACH-INCORSTROM ASSOCIATES, INC. MAKES NO PURPOSE AND ASSOCIATES, INC. MAKES NO PURPOSE AND ASSOCIATES, INC. MAKES NO PURPOSE AND ASSOCIATES, INC. MAKES NO PURPOSE OF A BANDONED FURTHER, KEACH-HORDSTROM HARE, STHER IN SERVICE OR ABANDONED FURTHER, KEACH-HORDSTROM HARE, STHER IN SERVICE OR ABANDONED FURTHER, KEACH-HORDSTROM HARE, STROM HARE IN THE EXCHAPATE THAT THE UNDERGROUND HILLIES SHOWN ARE IN THE EXCHAPATE AND PROMISE AND ASSOCIATES, INC. HOR MAKE HARE CHORDSTROM ASSOCIATES, INC. HOR PHYSICALLY LOCATED THE UNDERGROUND PORTIONS OF THE UTILITIES.

NPDES NOTE

THIS PROJECT DISTURBS IN EXCESS OF 1—ACRE OF LAND.
THEREFORE IT WILL BE REQUIRED TO OBTAIN NATIONAL POLLUTANT
DISCHARGE ELIMINATION SYSTEM (IPDES) PERMIT COVERAGE AS:
ISSUED BY THE ENVIRONMENTAL PROTECTION AGENCY (EPA). THE
OWNER/DEVELOPER AND "OPERATOR" (GENERAL CONTRACTOR)
SHALL EACH BE REQUIRED TO PREPARE AND SUBMIT A NOTICE OF
INTENT (NO) TO THE EPA PRIOR TO THE START OF CONSTRUCTION
AND SHALL BE RESPONSIBLE FOR THE PREPARATION AND
HIGHERINATION OF A STORM WATER POLLUTION PREVENTION PLAN
(ENDOR) LEEPING THE REQUIREDLENTS OF THE CHIEFENT (SWPPP) MEETING THE REQUIREMENTS OF THE CURRENT CONSTRUCTION CENERAL PERMIT.



LEGEND

TREELINE ■ GB-F GRANITE BOUND FOUND EDGE OF PAVEMENT STONE POST EDGE OF GRAVEL @ S8-F STONE BOUND FOUND ---- SETBACK € DH-S DRILL HOLE SET - EASEMENT **♦** WETLAND UTILITY POLE WE'TLAND BUFFER CATCH BASIN PROPOSED TREELINE PROPOSED CATCH BASIN PROPOSED BITUMINOUS CURB PROPOSED OUTLET STRUCTURE PROPOSED END SECTION PROPOSED UTILITY POLE PROPERTY LINE

- LANDSCAPE NOTES:

 1. THE PURPOSE OF THIS PLAN IS TO SHOW THE PROPOSED SITE LANDSCAPE WHICH PROVIDES CLIMATIC RELIEF AND AESTHETIC APPEAL.

 2. STRIPPED TOPSOIL SHALL BE STOCKPILED AND REUSED ON THE SITE WHERE NEEDED. TOPSOIL SHALL BE A MINIMUM OF 4 INCHES DEEP (MEASURED WHEN CONSOLIDATED). TOPSOIL SHALL BE TREATED IF NEEDED TO PROMOTE HEALTHY GRASS WHEN SEEDES CARRIEFY AND REPEAT SEEDING AS NECESSARY.

 3. SITE PREPARATION IS TO BE CONDUCTED WITH MINIMAL DISTURBANCE. TO EXISTING VEGETATION WHICH WILL REMAIN, CONSTRUCTION MATERIALS, EQUIPMENT, VEHICLES OR TEMPORARY SOIL DEPOSITS SHALL NOT BE LOCATED WITHIN THE DRIP—LINE OF TREES THAT ARE TO BE PRESERVED.

 2. EXISTING TREES WHICH REMAIN SHALL BE PRINED AND THINNED IF APPROPRIATE PER UNH COOPERATIVE EXTENSION RECOMMENDATIONS TO MAINTAIN HEALTHY APPEARANCES.

 3. ALL OPEN SPACE AREAS NOT COVERED WITH PLANTINGS SHALL BE COVERED WITH GRASS OR OTHER VEGETATIVE ORONIDORIES, WITH THE EXCEPTION OF PLANTING BEDS WHICH MAY BE MULCHED.

 4. WHERE SLOPES OF 33% OR GREATER ARE CREATED OR DISTURBED, THEY SHALL BE COVERED OR PLANTED WITH DEEP ROOTED SPECIES TO PREVENT EROSION.

 3. ALL DEAD, DYING, OR DISASSED VEGETATION SHALL BE PROMPTLY REPLACED. BASED ON SEASONAL PLANTING PRACTICES WITH HEALTHY SERVICE ACTION OF SHALL RECOURSED LANDSCAPE AREAS.

 4. ALL DEAD, DYING, OR DISASSED VEGETATION SHALL BE PROMPTLY REPLACED. BASED ON SEASONAL PLANTING PRACTICES ON DISASSED VEGETS TO A VEGETATION SHALL RECOURSED LANDSCAPE AREAS.


 5. PROVIDE A MAINTENANCED OR DIS WHITH ONCE YEAR AFTER HALL COMPLETION OF THE PROJECT.

 10. NO PLANTINGS SHALL CONFLICT WITH SNOW STORACE AREAS, LIGHT FIXTURES AND UNDERGROUND UTILITIES.

 11. NO LANDSCAPING CONFLICT WITH SNOW STORACE AREAS, LIGHT FIXTURES AND UNDERGROUND UTILITIES.

PROJECT PLANT LIST

SIZE HEIGHT SPREAD	COMMON NAME	BOTANICAL NAME		SYMBOL.
6'7' 8&B 30'-40' 30~40'	RED MAPLE	ACER RUBRUM "REDPOINTE"	3	0
2'-2.5' 9&8 8'-10' 6'-8'	MISS KIM ULAC	SYRINGA PATULA "MISS KIM"	8	8
# 7 6'-8" 4'-5'	VIBURNUM "BLUE MUFFIN"	MBURNUM DENTATUM	4	8
₫ 3 4'-8' 4'-8'	EARLY AZALEA	RHODODENDRON PRINOPHYLLUM	9	•
g 2 2'-3' 3'	DAYLILY	HEMEROCALLIS HYBRIDS	24	(FDL)
				_

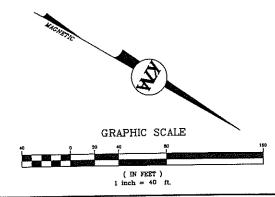


LANDSCAPE PLAN

JENNESSTOWN MANOR MAP 7, LOTS 39 & 39-1

ROUTE 103 WARNER, NEW HAMPSHIRE MERRIMACK COUNTY

OWNER/APPLICANT:

PEACOCK HILL ROAD, LLC 145 OLD TOWN ROAD WEARE, NH 03281 BK. 3829 PG. 2512

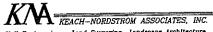


Civil Engineering Land Surveying Landscape Architecture namerce Park North, Suite 3B, Bedford, NH 03110 Phone (603) 527-2881

BY AEW

	T		REV	USIONS		
MINIBININA CONTRACTOR OF THE PARTY OF THE PA	No.	DATE		DESCR		
STEVEN HAMO	1	5/22/25	PER PB A	ND AOT	COMMENTS	3
STEVEN						
KEACH INO. 7659						
CENT AND		 				
CE STATE OF THE ST	DATI	E: MARCH 2	5, 2025		SCALE: 1"	= 40
annum)	PRO	JECT NO: 2	4-0307-1		SHEET 7	OF 16



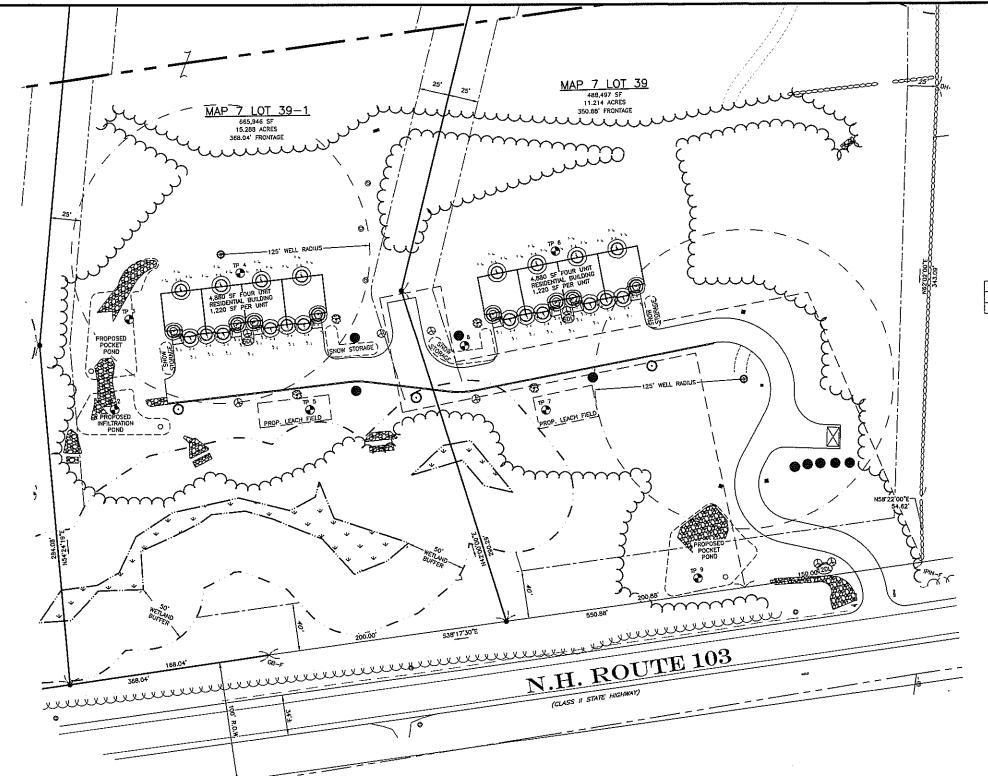

UTILITY NOTE

THE UNDERGROUND UTILITIES DEPICTED HEREON HAVE BEEN BRAWN FROM FIELD SURVEY INFORMATION AND OR PLOTTED FROM EXISTING DRAWNOS. KEACH-HORDSTROM ASSOCIATES, INC. MAKES NO GUARANTEES THAT THE UNDERGROUND UTILITIES DEPICTED COMPRISE ALL SUCH UTILITIES IN THE AREA, EITHER IN SERVICE OR ABANDONED FURTHER, KEACH-HORDSTROM ASSOCIATES, INC. DOES NOT MARRANT THAT THE UNDERGROUND UTILITIES SHOWN ARE IN THE SECURITARY AS POSSIBLE FROM THE INFORMATION AVAILABLE, KEACH-HORDSTROM ASSOCIATES, INC. HORDSTROM ASSOCIATES,

NPDES NOTE

THIS PROJECT DISTURBS IN EXCESS OF 1—ACRE OF LAND. THEREFORE IT WILL BE REQUIRED TO OBTAIN NATIONAL POLLUTANT DISCHARGE ELIMINATION SYSTEM (INPOES) PERMIT COVERAGE AS ISSUED BY THE ENVIRONMENTAL PROTECTION AGENCY (EPA). THE OWNER/DEVELOPER AND "OPERATOR" (GENERAL CONTRACTOR) SHALL EACH BE REQUIRED TO PREPARE AND SUBMIT A NOTICE OF INTENT (NO!) TO THE EPA PRIOR TO THE START OF CONSTRUCTION AND SHALL BE RESPONSIBLE FOR THE PREPARATION AND IMPLEMENTATION OF A STORM WATER POLLUTION PREVENTION PLAN (SWPPP) MESTING THE REQUIREMENTS OF THE CURRENT CONSTRUCTION GENERAL PERMIT.



LEGEND

TREELINE EI GB-F GRANITE BOUND FOUND EDGE OF PAVEMENT 0.59 STONE POST ---- EDGE OF GRAVEL @ S8-F STONE BOUND FOUND ---- SETBACK ⊕ DH-S DRILL HOLE SET — — — EASEMENT WETLAND UTILITY POLE --- --- WETLAND BUFFER CATCH BASIN PROPOSED TREELINE
PROPOSED BITUMINOUS CURB PROPOSED CATCH BASIN PROPOSED OUTLET STRUCTURE ----- ABUTTER LINE PROPOSED END SECTION - PROPERTY LINE PROPOSED UTILITY POLE

- EXTERIOR LIGHTING


 EXTERIOR

 EXTERIOR LIGHTING

 EXTERIOR


 EXTERIOR

Luminaire Schedule Arrangement Description [MANUFAC]
Single 47356-016 EUROFASE Qty Label 47356-016 W Single

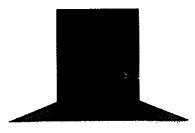

DECKARD, 12IN INTEGRATED LED OUTDOOR WALL LANTERN

NOT TO SCALE

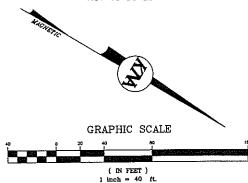


LIGHTING PLAN

JENNESSTOWN MANOR MAP 7, LOTS 39 & 39-1


ROUTE 103 WARNER, NEW HAMPSHIRE MERRIMACK COUNTY


OWNER/APPLICANT:


PEACOCK HILL ROAD, LLC 145 OLD TOWN ROAD WEARE, NH 03281 BK. 3829 PG. 2512

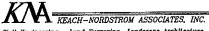

Civil Engineering Land Surveying Landscape Architecture 10 Commerce Park North, Suite 3B, Bedford, NH 03110 Phone (803) 627-2881

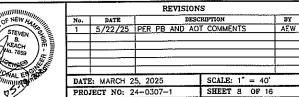

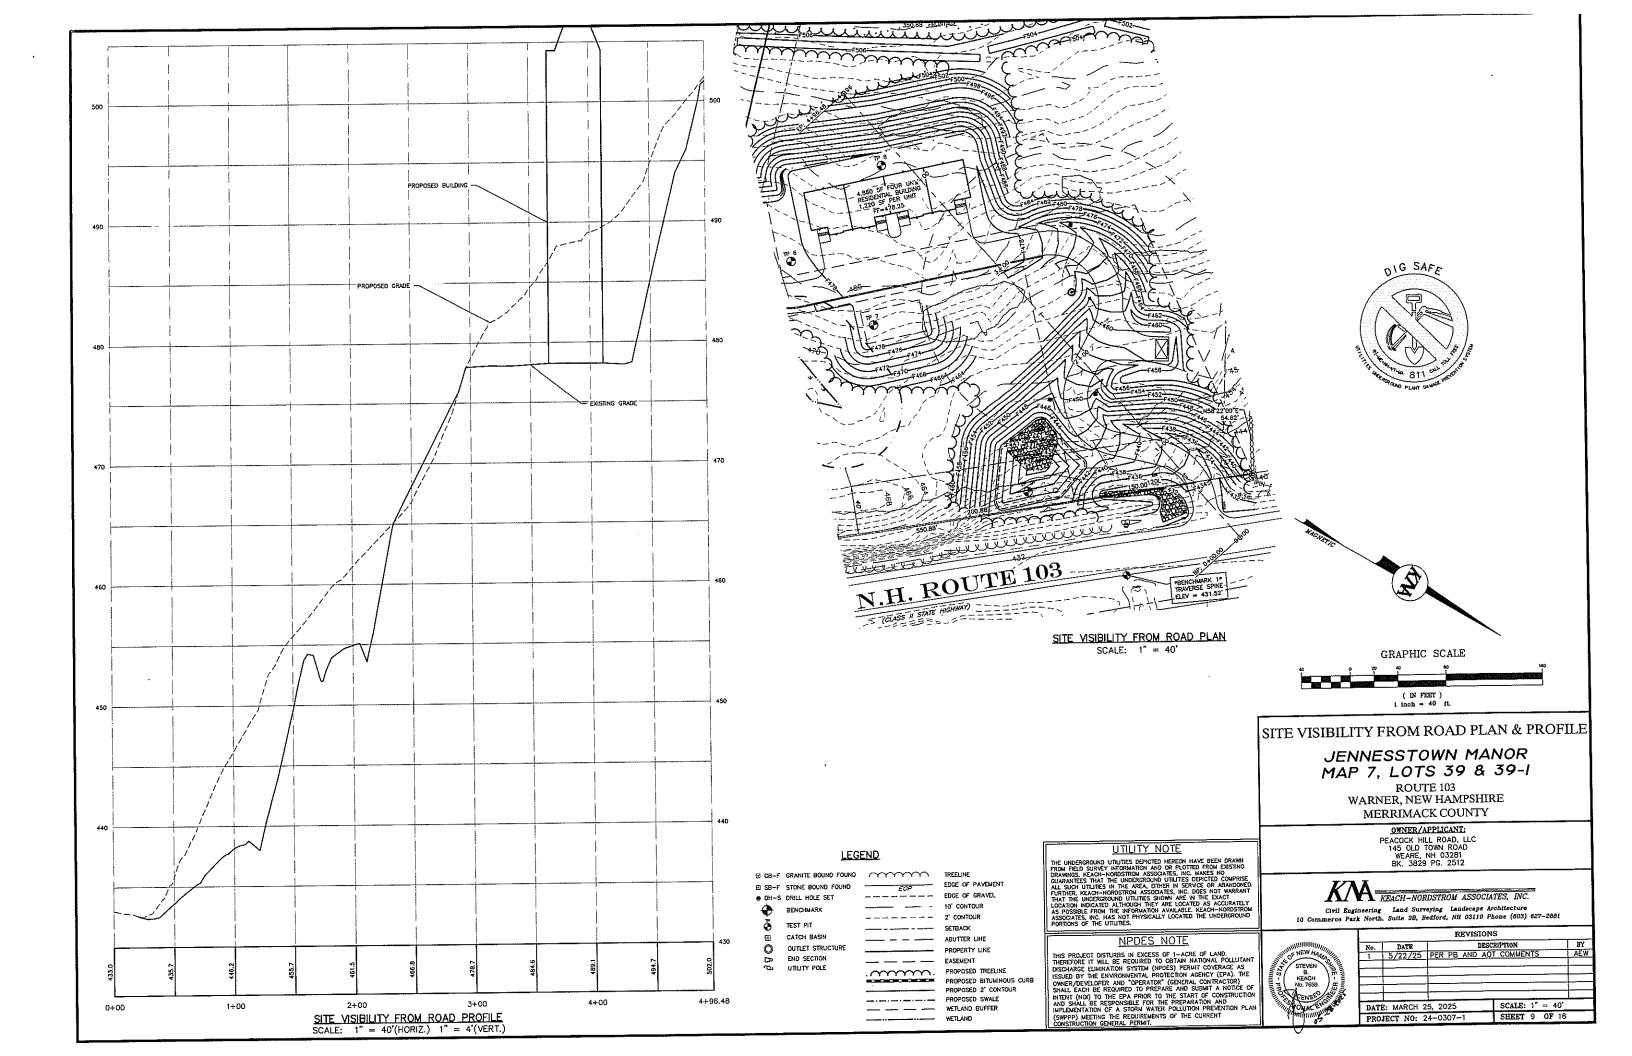


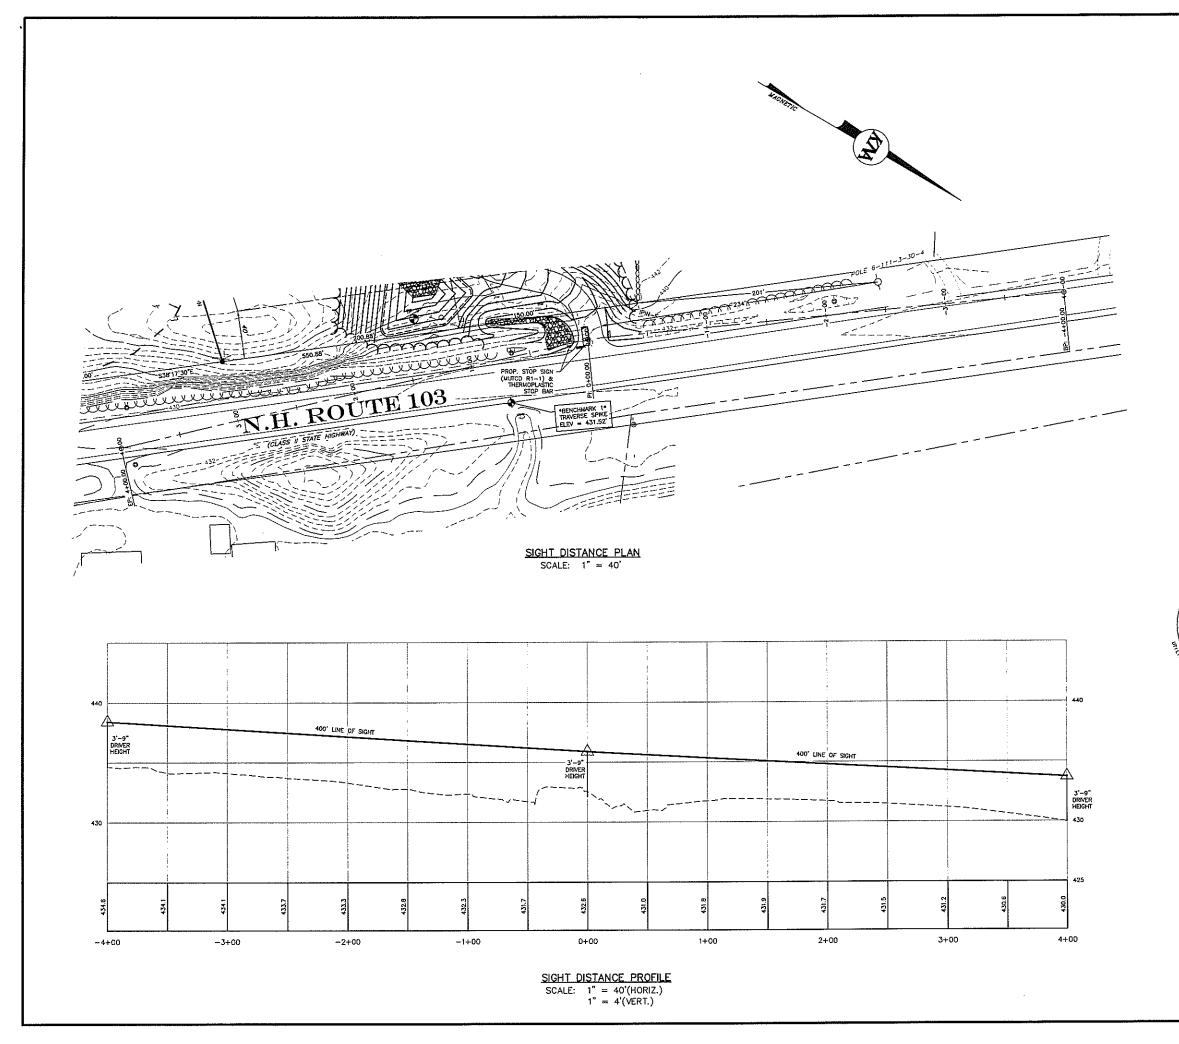

NOTES:

1. THE PURPOSE OF THIS PLAN IS TO DEPICT THE SIGHT DISTANCE FOR MAP 7 LOT 39 IN WARNER, NEW HAMPSHIRE.

- 2. THE POSTED SPEED LIMIT ON ROUTE 103 IS 50 MPH.
- ALL WORK PERFORMED WITHIN THE STATE R.O.W. SHALL BE IN ACCORDANCE WITH THE LATEST EDITION OF THE NHOOT STANDARD SPECIFICATIONS AND DETAILS.
- 4. LANDOWNER SHALL REMOVE VEGETATION AND OBSTRUCTIONS AS NEEDED TO MAINTAIN ALL SEASON SIGHT DISTANCE.

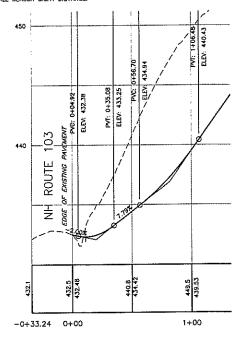

DRIVEWAY PROFILE

SCALE: 1'' = 40'(HORIZ.)1'' = 4'(VERT.)

GRAPHIC SCALE





UTILITY NOTE

THE UNDERGROUND UTILITIES DEPICTED HEREON HAVE BEEN DRAWN FROM FIELD SURVEY INFORMATION AND OR PLOTTED FROM EXISTING DRAWNOS. KEACH-HORDSTROM ASSOCIATES, INC. MAKES NO GUARANTEES THAT THE UNDERGROUND UTILITIES DEPICTED COMPRISE ALL SUCH UTILITIES IN THE MERE, ETHER IN SERVICE OR ASANDONED FURTHER, KEACH-HORDSTROM ASSOCIATES, INC. DOES NOT MARRANT DAYS THE REPORT OF THE MERCHANDER OF THE ASSOCIATES, INC. MASSOCIATES, INC. M

SITE DISTANCE PLAN

JENNESSTOWN MANOR MAP 7, LOTS 39 & 39-1

ROUTE 103 WARNER, NEW HAMPSHIRE MERRIMACK COUNTY

OWNER/APPLICANT:
PEACOCK HILL ROAD, LLC
145 OLD TOWN ROAD
WEARE, NH 03281
BK. 3829 PG. 2512



KA KEACH-NORDSTROM ASSOCIATES, INC.

Civil Engineering Land Surveying Landscape Architecture 10 Commerce Park North, Suite 3B, Bedford, NH 03110 Phone (603) 627-2881


REVISIONS SCALE: 1" = 40' DATE: MARCH 25, 2025 SHEET 10 OF 16 PROJECT NO: 24-0307-1

EXISTING GRADE -1.127 LOW POINT ELEV = 432.32 LOW POINT STA = 0+20.00 POINT STA = 0+20.00 POINT = 0+20.00 AD. = 3.08 K = 3.08 30° VC NH 482.2 4+00 5+00 6+00 3+00 2+00 -0+33.24 0+00



UTILITY NOTE

THE UNDERCROUND UTILITIES DEPICTED HEREON HAVE BEEN DRAWN FROM FIELD SURVEY INFORMATION AND OR PLOTTED FROM EXISTING DRAWNINGS, KEACH-NORDSTROM ASSOCIATES, RIC, MAKES NO GUARANIESE THAT THE UNDERCROUND UTILITIES DEPICTED COMPRISE ALL SUCH UTILITIES IN THE AREA, ETHER IN SERVICE OR ABANDONED FURTHER, KEACH-NORDSTROM ASSOCIATES, RIC, COSS NOT WARRANT THAT THE UNDERGROUND UTILITIES SHOWN ARE IN THE EXACTLY AS POSSIBLE FROM THE INFORMATION AVAILABLE, KEACH-NORDSTROM ASSOCIATES, RIC, HAS NOT PHYSICALLY LOCATED THE UNDERGROUND PORTIONS OF THE UTILITIES.

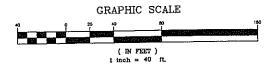

DRIVEWAY PROFILE PLAN

JENNESSTOWN MANOR MAP 7, LOTS 39 & 39-1

ROUTE 103 WARNER, NEW HAMPSHIRE MERRIMACK COUNTY

OWNER/APPLICANT:
PEACOCK HILL ROAD, LLC
145 OLD TOWN ROAD
WEARE, NH D3281
BK. 3829 PG. 2512





KEACH-NORDSTROM ASSOCIATES, INC.

Civil Engineering Land Surveying Landscape Architecture 10 Commerce Park North, Suite 3B, Bedford, NH 03110 Phone (603) 627-2881


No. DATE DESCRIPTION BY 1 5/22/25 PER PS AND AOT COMMENTS AEW DATE: MARCH 25, 2025 SCALE: 1" = 40'			REVISIO	ONS	
1 5/22/25 PER PB AND AOT COMMENTS AEW	No.				
	1	5/22/25	PER PB AND A	OT COMMENTS	AEW
					1_
				SCALE: 1" = 40'	Ι

DRIVEWAY PROFILE SCALE: 1'' = 40'(HORIZ.)1'' = 4'(VERT.)

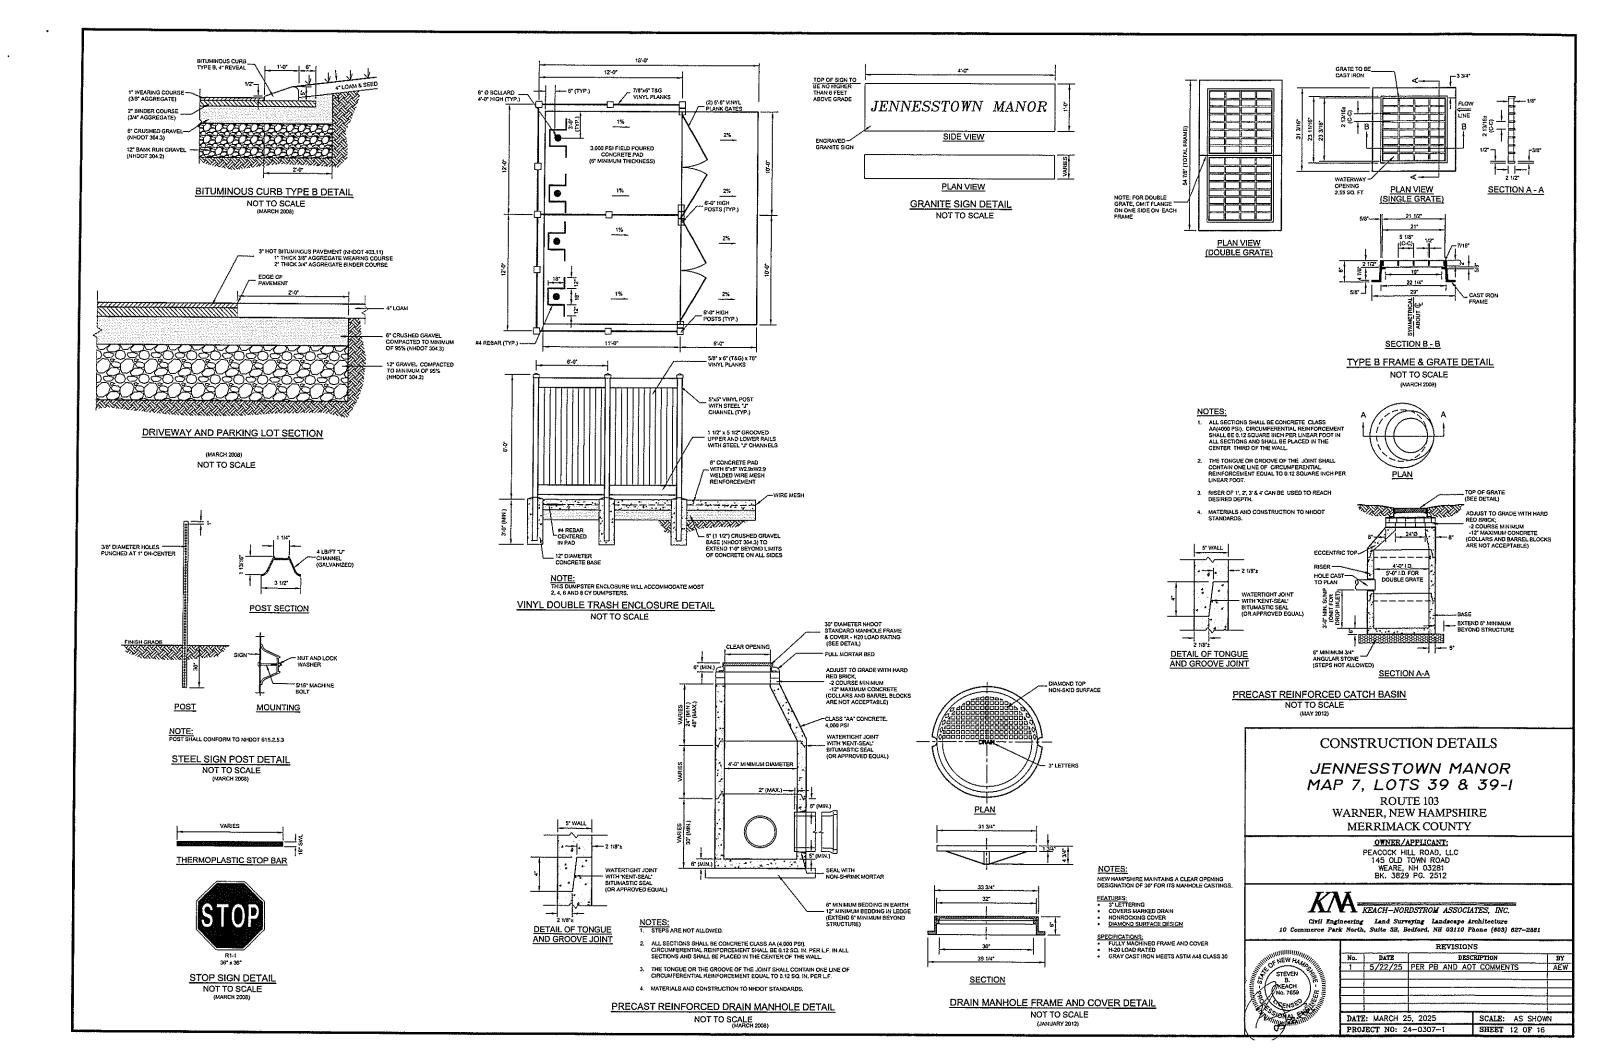

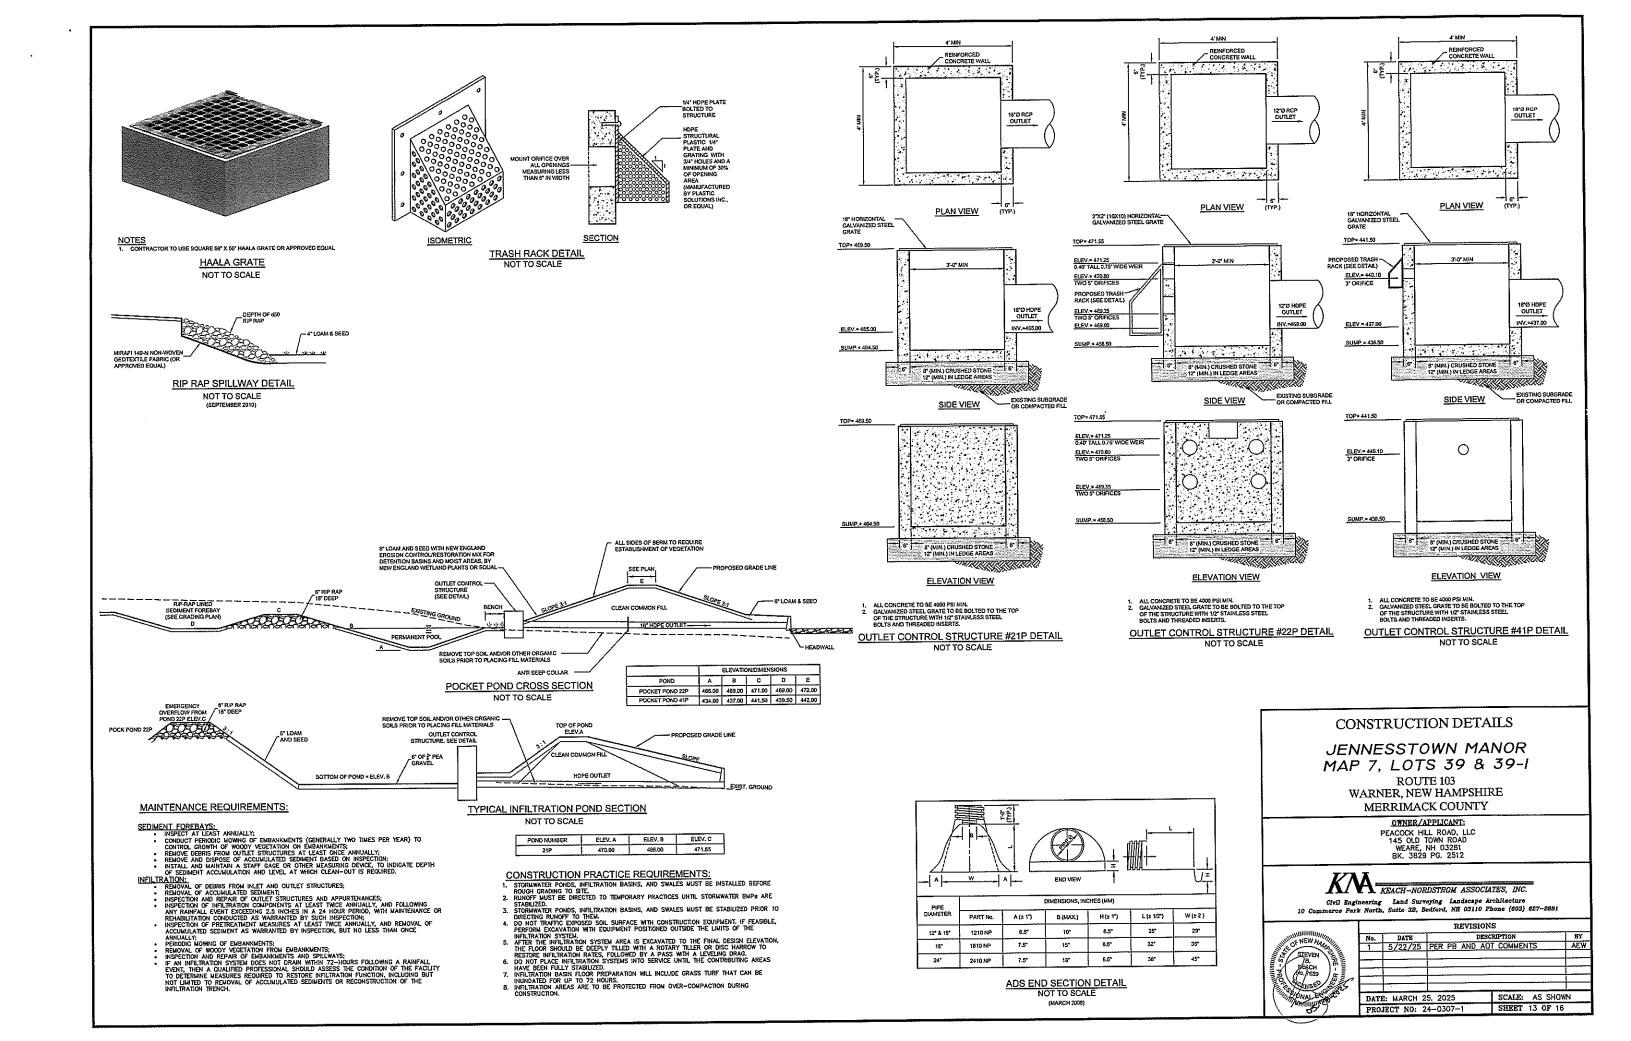

RADATION OF STO	NE FOR LEVEL SPREADER
NEVE DESIGNATION	PERCENT BY WEIGHT PASSING SQUARE MESH SIEVES
12 INCH	100%
8 INCH	84 - 100%
3 INCH	68 - 83%
1 INCH	42 - 55%
NO.4	8 - 12%

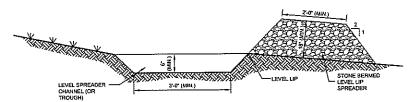

- NOTIES:

 1 CONSTRUCT THE LEVEL SPREADER UP ON A ZERO PERCENT GRADE TO INSURE UNIFORM SPREADING OF RUN-OFF.

 2. LEVEL SPREADER SHALL SE CONSTRUCTED ON IMPOISTURBED SOIL. AND NOT ON FILL.

 3. THE FLOW FROM THE LEVEL SPREADER SHALL OUTLET INTO STABILIZED AREAS. WATER SHOULD NOT RECONCENTRATE IMMEDIATELY BELOW THE SPREADER.

 4. PERIODIC INSPECTION AND REQUIRED MAINTENANCE SHALL BE PERFORMED.

- MAINTENANCE REQUIREMENTS:

 1. INSPECT AT LEAST ONCE ANNUALLY FOR ACCUMULATION OF SEDIMENT AND DEBRIS AND FOR SIGNS OF EROSION WITHIN APPROACH CHANNEL, SPREADER CHANNEL OR DOWN SLOPE OF THE SPREADER.

 2. REMOVE DEBRIS WHENEVER OBSERVED DURING INSPECTION.

 3. REMOVE SEDIMENT WHEN ACCUMULATION DECREEDS 25% OF SPREADER CHANNEL DE PTIM.


 4. MOW AS RECURRED BY LAND DESIGN. AT AN IMMUM, SPREADER CHANNEL DE PTIM.

 5. SHOW SHOULD NOT BE STORED WITHIN OR DOWN-SLOPE OF THE LEVEL SPREADER OR ITS APPROACH CHANNEL.

 6. REPAIR ANY EROSION AND RIS-GRADE OR REPLACE STONE SERM MATERIAL, AS WARRANTED BY INSPECTION.

 7. RECONSTRUCT THE SPREADER IF DOWN-SLOPE CHANNEL/ZATION HIGHCATES THAT THE SPREADER IS NOT LEVEL OR THAT DISCHARGE HAS BECOME CONCENTRATED, AND CORRECTIONS CANNOT BE MADE THROUGH MINOR RE-GRADING.

STONED BERMED LEVEL LIP SPREADER DETAIL NOT TO SCALE

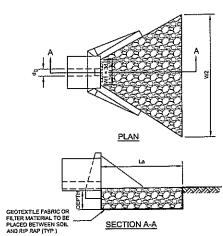

PIPE OUTLET TO FLAT AREA WITH NO DEFINED CHANNEL

(MAKCH 2000)					
	ELE	VATION	DIMENS	SIONS	
LOCATION	LENGTHFT	W1 FT	W2 FT	d50 IN.	DEPTH IN.
POCKET POND 41P OUTLET	11	5	16	4	10
INFILTRATION POND 21P OUTLET	13	5	18	5	18
POCKET POND 22P OUTLET	13	3	18	6	18
DMH 211P OUTLET (HW #210)	14	5	19	3	18


TABLE 7-24 RECOMMENDED	RIP RAP GRADATION RANGES
PERCENT OF WEIGHT SMALLER THAN THE GIVEN SIZE	SIZE OF STONE
100% 85% 50% 15%	1.5 TO 2.0 d50 1.3 TO 1.8 d50 1.0 TO 1.5 d50 0.3 TO 0.5 d50

CONSTRUCTION SPECIFICATIONS:

- THE SUBGRADE FOR THE FILTER MATERIAL, GEOTEXTILE FABRIC AND RIP RAP SHALL BE PREPARED TO THE LINES AND GRADES SHOWN ON THE PLANS.
- THE ROCK OR GRAVEL USED FOR FILTER OR RIP RAP SHALL CONFORM TO THE SPECIFIED GRADATION.
- 3. GEOTEXTILE FABRICS SHALL BE PROTECTED FROM PUNCTURE OR TEARING OURING THE PLACEMENT OF THE ROOK RIP RAP. DAMAGED ARKS IN THE FABRIC SHALL BE REPAIRED BY PLACING A PIECE OF FABRIC OVER THE DAMAGED AREA OR BY COMPLETE REPLACEMENT OF THE FABRIC, ALL OVERLAPS REQUIRED FOR REPAIRS OR JOINING TWO PIECES OF FABRIC SHALL BE A MINIMUM OF 12 INCHES.
- 4. STONE FOR THE RIP RAP MAY BE PLACED BY EQUIPMENT AND SHALL BE CONSTRUCTED TO THE FULL LAYER THICKNESS IN ONE OPERATION AND IN SUCH A MANNER AS TO PREVENT SEGREGATION OF THE STONE SIZES.

MAINTENANCE:

MAINTENANCE:
THE DULLET PROTECTION SHOULD BE CHECKED AT LEAST ANNUALLY AND AFTER EVERY NAJOR RAIN EVERY. IF THE RIP RAP HAS BEEN OBPLACED, UNDERSMIKED, ON EDMAGED, IS HOULD BE REPAIRED IMMEDIATELY. THE CHANNEL IMMEDIATELY BELOW THE OUTLET SHOULD BE CHECKED TO SEE THAT EROSION IS NOT OCCURRING. THE DOWNSTREAM CHANNEL SHOULD BE KEPT CLEAR OF OBSTRUCTIONS SUCH AS FALLEN TIERES, DEBRIS, AND SEDIMENT THAT COULD CHANGE FLOW PATTERNS ANDIOR TAILWATER DEPTHS ON THE PIPES. REPAIRS MUST BE CARRIED OUT IMMEDIATELY TO AVOID ADDITIONAL DAMAGE TO THE OUTLET PROTECTION APRON.

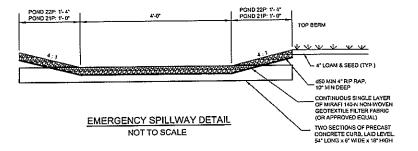

CONSTRUCTION DETAILS

JENNESSTOWN MANOR MAP 7, LOTS 39 & 39-1

ROUTE 103 WARNER, NEW HAMPSHIRE MERRIMACK COUNTY

OWNER/APPLICANT:
PEACOCK HILL ROAD, LLC
145 OLD TOWN ROAD
WEARE, NH 03281
BK. 3829 PG. 2512





KEACH-NORDSTROM ASSOCIATES, INC.

Civil Engineering Land Surveying Landscape Architecture 10 Commerce Park North, Suite 3B, Bedford, NE 03110 Phone (603) 627-2881



		REVISI	ons	
No.	DATE	D	ESCRIPTION	BY
1	5/22/25	PER PB AND	AOT_COMMENTS	AEW
		<u> </u>		
				_
				
DATI	E: MARCH 2	5, 2025	SCALE: AS SH	OWN
PRO.	JECT NO: 2	4-0307-1	SHEET 14 OF	16

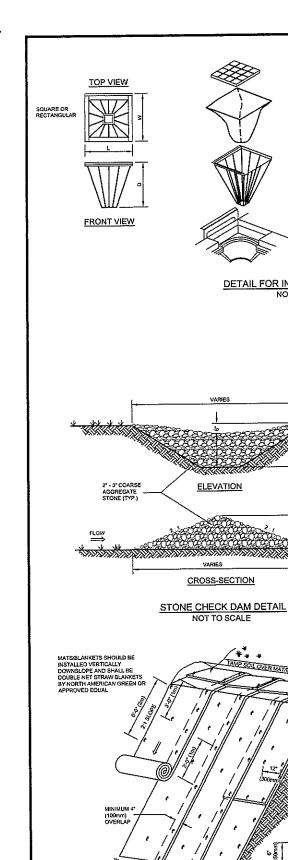

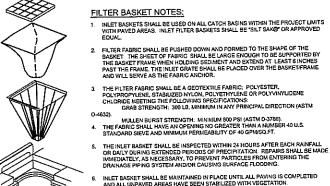

DETAIL FOR INLET FILTER BASKET NOT TO SCALE

TAMP SOIL OVER MAT/BLANKET

ISOMETRIC VIEW

SLOPE SURFACE SHALL BE FREE OF ROCKS, CLODS, STICKS AND GRASS. MATS/BLANKETS SHALL HAVE GOOD SOIL CONTACT APPLY PERMANENT SEEDING BEFORE PLACING

2. APPLY PERBANCENT CONTACT WITH THE SOIL DO NOT STRETCH.

3. LAY BLANKETS LOOSELY AND STAKE OR STAPLE

1. TO MAINTAIN DIRECT CONTACT WITH THE SOIL DO NOT STRETCH.

4. UTILIZE "WILDLIFE FRIENDLY" MATTING CONSISTING OF COCO OR JUTE, AND LACKING PLASTIC MESH TO PROTECT SNAKES, WELDED PLASTIC OR BIODOGRADABLE PLASTIC NETTING OR


MESH TO PROTECT SNAKES, WELDED PLASTIC OR BIODOGRADABLE PLASTIC NETTING OR

EROSION CONTROL BLANKETS - SLOPE INSTALLATION

NOT TO SCALE

0.14 STAPLES

4'-0" (1.2m)

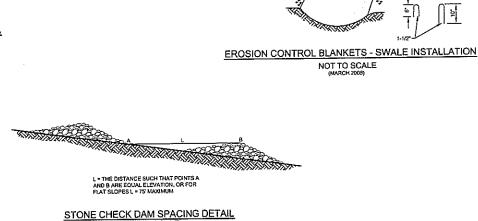

NOT TO SCALE

-3/4"x 1-3/4"x 4" WOOD STAKE, OR APPROVED EQUAL SILT FENCE MIRAFI 100X, OR APPROVED EQUAL FLOW DOWNHILL SIDE PLACE 4" OF FABRIC — ALONG TRENCH AWAY FROM PROTECTED AREA BACKFILL AND TAMP WOVEN WIRE FENCE 6"x6"x14,5 GAGE UNDISTURBED FLOW PERSPECTIVE VIEW

SILT FENCE DETAIL

NOT TO SCALE

SECTION

CONSTRUCTION SPECIFICATIONS:

- THE GEOTEXTILE FABRIC SHALL MEET THE DESIGN CRITERIA FOR SILT FENCES.
- THE FABRIC SHALL BE EMBEDDED A MINIMUM OF 8 INCHES INTO THE GROUND AND THE SOIL COMPACTED OVER THE EMBEDDED FABRIC.
- WOVEN WIRE FENCE SHALL BE FASTENED SECURELY TO THE FENCE POSTS WITH WIRE TIE OR STAPLES WHERE NOTED OR AS DIRECTED BY DESIGN ENGINEER.
- FILTER CLOTH SHALL BE FASTENED SECURELY TO THE WOVEN WIRE FENCE WITH TIES SPACED EVERY 24 INCHES AT THE TOP, MIDSECTION AND BOTTOM.
- 5. WHEN TWO SECTIONS OF FILTER CLOTH ADJOIN EACH OTHER, THEY SHALL SE OVERLAPPED BY 6 INCHES, FOLDED AND STAPLED. 6. FENCE POSTS SHALL BE A MINIMUM OF 36 INCHES LONG AND DRIVEN A MINIMUM OF 16 INCHES INTO THE GROUND. WOOD POSTS SHALL BE OF SOURD QUALITY HADDWOOD AND SHALL HAVE A MINIMUM CROSS SECTIONAL AREA OF 3.0 SQUARE INCHES.
- MAINTENANCE SHALL BE PERFORMED AS NEEDED AND MATERIAL REMOVED WHEN "BULGES" DEVELOP IN THE SILT FENCE.

MAINTENANCE:

- SILT FENCES SHALL BE INSPECTED IMMEDIATELY AFTER EACH RAINFALL AND AT LEAST DAILY DURING PROLONGED RAINFALL. ANY REPAIRS THAT ARE REQUIRED SHALL BE MADE IMMEDIATELY
- IF THE FABRIC ON A SILT FENCE SHOULD DECOMPOSE OR BECOME INEFFECTIVE DURING THE EXPECTED LIFE OF THE FENCE, THE FABRIC SHALL BE REPLACED PROMPTLY.
- SEDIMENT DEPOSITS SHOULD BE INSPECTED AFTER EVERY STORM EVENT. THE DEPOSITS SHOULD BE REMOVED WHEN THEY REACH APPROXIMATELY ONE-HALF THE HEIGHT OF THE BARRIER.
- SEDIMENT DEPOSITS THAT ARE REMOVED OR LEFT IN PLACE AFTER THE FABRIC HAS BEEN REMOVED SHALL BE GRADED TO CONFORM WITH THE EXISTING TOPOGRAPHY AND VEGETATED.

MATS/BLANKETS

SHOULD BE INSTALLED VERTICALLY DOWNSLOPE AND

DOWNSLOPE AND SHALL BE DOUBLE NET STRAW BLANKETS BY NORTH AMERICAN GREEN OR APPROVED EQUAL

4 INCH OVERLAP OF JUTE STRIPS WHERE TWO OR MORE STRIP WIDTHS ARE REQUIRED (STAPLE ON 18

TAMP THE TRENCH FULL OF SOIL SECURE WITH ROW OF STAPLES, 6 INCH SPACING, 4 INCHES DOWN FROM THE TRENCH.

OVERLAP: BURY UPPER END OF LOWER STRIP AS IN "A" AND "B". OVERLAP END OF TOP STRIP 4 INCHES AND STAPLE.


EROSION STOP: FOLD OF JUTE BURIED IN SILT TRENCH AND TAMPED; DOUBLE ROW

MUD AND SOIL PARTICLES WILL EVENTUALLY CLOS THE VOIDS IN THE CRUSHED STONE AND THE FERCTIVENESS OF THE CRUSHED STONE PAD WILL NOT BE SATISFACTORY. WHEN THIS COCURS, THE PAD SHOULD BE TOPDRESSED WITH NEW CRUSHED STONE OR COMPLETE REPLACEMENT OF THE PAD MAY BE NECESSARY WHEN THE PAD BECOMES COMPLETELY CLOSED.

IF WASHING FACILITIES ARE USED, THE SEDIMENT TRAPS SHOULD BE CLEANED OUT AS OFFEN AS NECESSARY TO ASSURE THAT ADEQUATE TRAPPING EFFICIENCY AND STORAGE VOLUME IS AVAILABLE. VEGETATIVE FILTER STRIPS SHOULD BE MAINTAINED TO INSURE A VIGOROUS STAND OF VEGETATION AT ALL TIMES.

CONSTRUCTION SPECIFICATIONS:

- STONE FOR A STABILIZED CONSTRUCTION EXIT SHALL BE 3 INCH STONE, RECLAIMED STONE OR RECYCLED CONCRETE EQUIVALENT.
- THE LENGTH OF THE STABILIZED EXIT SHALL NOT BE LESS THAN SO FEET, EXCEPT FOR A SINGLE RESIDENTIAL LOT WHERE A 30 FOOT MINIMUM LENGTH WOULD APPLY.
- THE THICKNESS OF THE STONE FOR THE STABILIZED EXIT SHALL NOT BE LESS THAN 6 INCHES.
- THE WIDTH OF THE EXIT SHALL NOT BE LESS THAN THE FULL WIDTH OF THE AREA WHERE INGRESS OR EGRESS OCCURS OR 10 FEET, WHICHEVER IS GREATER.
- GEOTEXTILE FILTER CLOTH SHALL BE PLACED OVER THE ENTIRE AREA PRIOR TO PLACING THE STONE. FILTER CLOTH IS NOT REQUIRED FOR A SINGLE FAMILY RESIDENCE LOT.
- ALL SURPACE WATER THAT IS FLOWING TO OR DIVERTED TOWARD THE CONSTRUCTION
 EXIT SHALL BE PIPED BENEATH THE EXIT. IF PIPING IS IMPRACTICAL, A BERM WITH 5.1
 SLOPES THAT CAM BE CROSSED BY VEHICLES MAY BE SUBSTITUTED FOR THE PIPE.
- 7. THE EXIT SHALL BE MAINTAINED IN A CONDITION THAT WILL PREVENT TRACKING OR FLOWING OF SEDMENT ONTO PUBLIC RIGHTS-OF-WAY. THIS MAY REQUIRE PERIODIC TOPORESSING WITH ADDITIONAL STONE AS CONDITIONS DEMAND AND REPAIR AND/OR CLEANOUT OF ANY MEASURES USED TO TRAP SEDMENT. ALL SEDMENT SPILED. WASHED OR TRACKED ONTO PUBLIC RIGHT-OF-WAY MUST BE REMOVED PROMPTLY.
- WHEELS SHALL BE CLEANED TO REMOVE MUD PRIOR TO ENTRANCE ONTO PUBLIC RIGHTS-OF-WAY, WHEN WASHING IS REQUIRED, IT SHALL BE DONE ON AN AREA STABILIZED WITH STONE WHICH DRAINS INTO AN APPROVED SEDIMENT TRAPPING

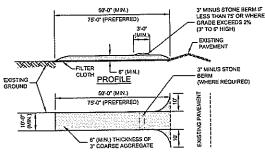


PLAN VIEW

STABILIZED CONSTRUCTION EXIT DETAIL

NOT TO SCALE

AREA TO BE WATER FLOW FILTREXX[®]COMPOST SILTSOXX® WORK AREA

STAKE ON 10'

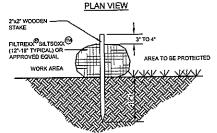

SECTION VIEW

NOTES:

1. ALL MATERIAL TO MEET FILTREXX® SPECIFICATIONS.

- 2. SILTSOXX®COMPOST/SOIL/ROCK/SEED FILL TO MEET APPLICATION REQUIREMENTS.
- SILTSOXX DEPICTED IS FOR MINIMUM SLOPES. GREAT SLOPES MAY REQUIRE LARGER SOCKS PER THE ENGINEER.
- 4. COMPOST MATERIAL TO BE DISPERSED ON SITE, AS DETERMINED BY ENGINEER

FILTREXX® SILTSOXX®DETAIL NOT TO SCALE

CONSTRUCTION SEQUENCE

- CONSTRUCTION SEQUENCE

 1. FIRST CUT AND CLEAR TREES AND BRUSH ONLY WITHIN DESIGNATED LIMITS OF CLEARING AS NECESSARY TO FACILITATE PROPOSED CONSTRUCTION. ALL TREES, BRANCHES AND OTHER VEGETATIVE MATERIALS SHALL BE PROPERTY DISPOSED OF FOR SITE BY THE CONTRACTOR. THIS PROJECT IS MANAGED TO MEET THE REQUIREMENTS AND INTENT OF SITE BY THE CONTRACTOR. THIS PROJECT IS MANAGED TO MEET THE REQUIREMENTS AND INTENT OF ANY SAST HINKOVING OPERATIONS, ALL A PULLCASE TEMPORARY SEOSION CONTROL MEASURES. INCLUDING SPECIFIED PERIMETER SILTATION FENCING AND STABILLED CONSTRUCTION EXIT SHALL BE IN PLACE AS SHOWN ON THE PROJECT FLANS.

 COMPLETE GRUBBING OPERATIONS. ALL STUMPS AND SIMILAR ORGANIC DEBRIS SHALL BE PROPERTY DISPOSED OF BY THE CONTRACTOR. NATIVE ORGANIC SOIL MATERIALS SUTTABLE FOR USE AS TOPSOL SHALL BE STOCKPILED WITHIN AREAS OUT OF THE WAY OF OTHER CONSTRUCTION SCITTINGS AND DRAINAGE FLOW. STOCKPILED WITHIN AREAS OUT OF THE WAY OF OTHER CONSTRUCTION SCITTINGS AND DRAINAGE FLOW. STOCKPILES SHALL BE TEMPORABILLY SECENDED WITH VINTER RYE AND BE SURROUNDED WITH HAY BALES AND/OR FABRIC SILTATION FERCE IN ORDER TO PREVENT LOSS DUE TO BESON TO BALANCE SITE AND PACILITATE BUILDING FOUNDATION AND RETAINING WALL COUSTRUCTION FERMANENT DOWNSLOPE WORK SHALL BE PROTECTED FROM UPGEAUGHEST STOKAMATER FLOW BY THE CONSTRUCTION OF TEMPORARY EARTHEN DIKES OR EXCAVATED SWALLS.

 ONCE BUILDING FOUNDATION WORK IS UNDERWAY, CONTINUE EARTHMOVING OPERATIONS UNTIL DESIGN SUBGRADE IS ACHIEVED.

- ONCE BUILDING FOUNDATION WORK IS UNDERWAY, CONTINUE DAY INMUNISOPARTICIDS OF LEGISLATION OF LOCAL SECTION OF THE WORK SUBGRADE IS ACHIEVED.

 INSTALL DRAINAGE SWALE SYSTEMS AND OTHER UTILITIES WORKING FROM LOW TO HIGH. INCOMPLETE WORK INSTALL DRAINAGE SWALE SYSTEMS AND OTHER UTILITIES WORKING FROM LOW TO HIGH. INCOMPLETE WORK SHALL BE PROTOCTED FROM SILTATION BY THE USE OF SILTATION BARRIERS AROUND SWALES UNTIL THE SITE HAS BECOME FULLY STABILIZED.

 PLACE GRAVEL AND CRUSHED GRAVEL OVER PROPOSED DRIVEWAY, WALKS AND PARKING AREAS AND COMPACT INSPECIED BY THE WORKING STABLE OF THE STABLE
- 7. PLACE GRAVEL AND CRUSHEU GRAVEL OVEN PROPOSED UNIVEWAY, WALAS AND PROVINCE AND ELABORY IN SPECIFICED LET THICKNESS.

 6. COMPLETE EXCAVATIONISTABILIZATION GRADING ACTIVITIES. WHEN COMPLETE, IMMEDIATELY BEGIN TOPSOLING PROPOSED TURFA REAS USING STOCKPILED LOAM SUPPLEMENTED WITH BORROW LOAM, IF NECESSARY, TO LEAVE A THICKNESS OF A INCHES OF FRIABLE LOAM.

 9. FINE GRADING IS COMPLETED. ALL AREAS SHALL BE STABILIZED WITHIN 72 HOURS OF ACHIEVING FINISH GRADE.

 10. INSTALL THE BINDER COURSE OF PAVEWENT OVER ALL DESIGNATED AREAS.

 11. CONTINUE TO MONITOR AND RECTIFY MINOR SITE AND SLOPE EROSION UNTIL BRITES ETTE APPEARS TO BE COMPLETELY STABILIZED AND VEGETATED WITH HE AREAT STAND OF THEY OR GROUND COVER, MAINTAIN SPECIFIED SILTATION/EROSION CONTROL MEASURES THROUGH ONE WINTER.

 12. INSTALL THE SPECIFIED WARRING COURSE OF PAVEWENT OVER THE BURDER COURSE.

 13. COMPLETE INSTALLATION OF LANDSCAPING, SIGNAGE AND OTHER SITE AMENTIES.

EROSION CONTROL NOTES

- EROSION CONTROL MEASURES WHERE AND WHEN SPECIFIC SITE CONDITIONS AND/OK CONSTRUCTION
 METHODOLOGIES MAY WARRANT.

 9. AREAS HAVING FINISH GRADE SLOPES OF 3:1 OR STEEPER, SHALL SE STABILIZED WITH JUTE MATTING WHEN AND
 IF FIELD CONDITIONS WARRANT, OR IT SO ORDERED. JUTE MATTING INSTALLED TO CONFORM WITH THE
 RECOMMENDED BEST MANAGEMENT PRACTICE OUTLINED IN YOULINE 3 OF THE NEW HAMPSHIRE STORMWATER
 RECOMMENDED AND SEDIMENT CONTROLS DURING CONSTRUCTION.

 10. ALL DETENTION POONS AND TREATMENT SWALES SHALL SE CONSTRUCTED PRIOR TO ANY EARTH MOVING
 ACTIVITIES THAT WILL INFLUENCE STORMWATER RUNOFF.

 11. ALL ROZDWAYS AND PRAKING AREAS SHALL SE STABILIZED WITHIN 72 HOURS OF ACHIEVING FINISHED GRADE.

 12. ALL CUT AND FILL SLOPES SHALL BE STABILIZED WITHIN 72 HOURS OF ACHIEVING FINISHED GRADE.

- WINTER CONSTRUCTION NOTES:

 1. ALL PROPOSED POST-DEVELOPMENT VEGETATED AREAS WHICH DO NOT EXHIBIT A MINIMUM OF 85% VEGETATIVE GROWTH BY OCTOBER 15TH, OR WHICH ARE DISTURBED AFTER OCTOBER 15TH, SHALL BE STABLIZED BY SEEDING AND INSTALLING BROSION CONTROL BLANKETS OR SEGRATER THAN 1, AND SEEDING AND PLACING 3 TO 4 TONS OF MUICH PER ACRE, SECURED WITH ANCHORED NETTING, ELSEWHERE—THE PLACEMENT OF EROSION OR ON FROZEN GROUND AND SHALL BE COMPLETED IN ADVANCE OF THAW OR SPRING MELT EVENTS.
- OR ON PROZEM GROUND AND SHALL BE COMPLETED IN AUXILIZED IN THAN ON A PRINT MELL EVENTS.

 2. ALL DITCHES OR SWALES WHICH DO NOT EXHIBIT A MINIMUM OP 85% VEGETATIVE GROWTH BY OCTOBER 15TH, OR WHICH ARE DISTURBED AFTER OCTOBER 15TH, SHALL BE STABILIZED WITH STONE OR EROSION CONTROL BLANKETS APPROPRIATE FOR THE DESIGN FLOW CONDITIONS. A FETER OCTOBER 15TH, MICOMPLETE ROAD OR PARKING SURFACES SHALL BE PROTECTED WITH A MINIMUM OF 3 INCHES OF CRUSHED GRAVEL PER NIHOUT ITEM 30.4 3 OR. IF CONSTRUCTION IS TO CONTINUE THROUGH THE WINTER SEASON, BE CLEARED OF ANY ACCUMULATED SHOW AFTER EACH STORM EVENT.

 AN AREA SHALL BE CONSIDERED STABLE IF OWE OF THE FOLLOWING HAS OCCURRED:

 A. BASE COURSE GRAVELS ARE INSTALLED IN AREAS TO SE PAYED.

 B. A MINIMUM OF 85% VEGETATED GROWTH HAS SEEN ESTABLISHED;

 C. A MINIMUM OF 85% VEGETATED GROWTH HAS SEEN ESTABLISHED;

 C. A MINIMUM OF 85% VEGETATED GROWTH HAS SEEN ESTABLISHED;

 BEEN INSTALLED. OR

- BEEN INSTALLED, OR

 D. EROSION CONTROL BLANKETS HAVE BEEN PROPERLY INSTALLED.

CONSTRUCTION DETAILS

JENNESSTOWN MANOR MAP 7, LOTS 39 & 39-1

ROUTE 103 WARNER, NEW HAMPSHIRE MERRIMACK COUNTY


OWNER/APPLICANT:

PEACOCK HILL ROAD, LLC 145 OLD TOWN ROAD WEARE, NH 03281 BK. 3829 PG. 2512





KEACH-NORDSTROM ASSOCIATES, INC.

Civil Engineering Land Surveying Landscape Architecture 10 Commerce Park North, Suite 3B, Bedford, NH 03110 Phone (603) 627-2881

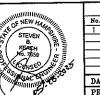


DATE DESCRIPTION 1 5/22/25 PER PB AND AOT COMMENTS SCALE: AS SHOWN DATE: MARCH 25, 2025 SHEET 15 OF 16 PROJECT NO: 24-0307-1

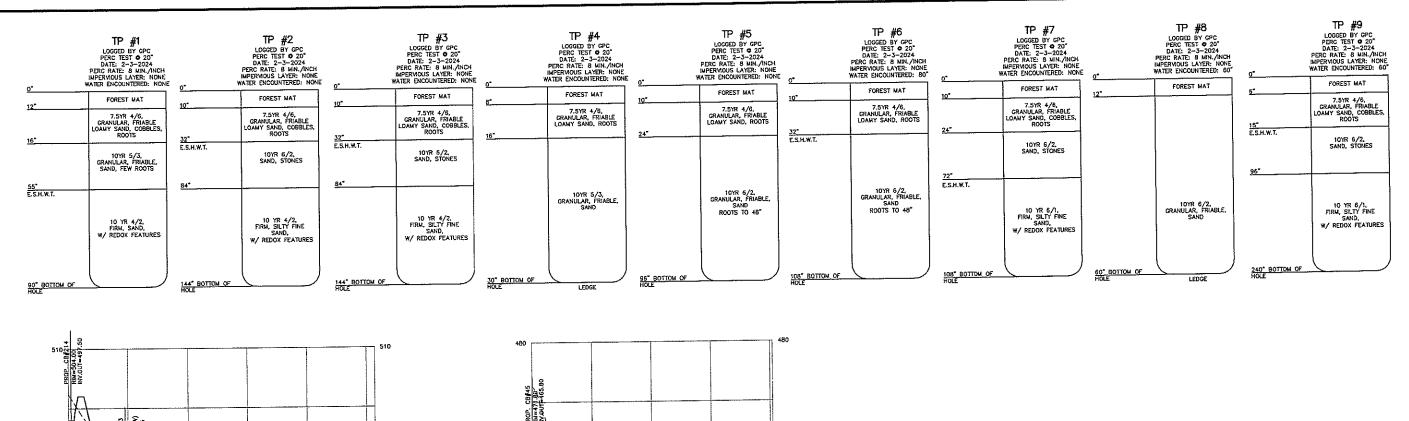

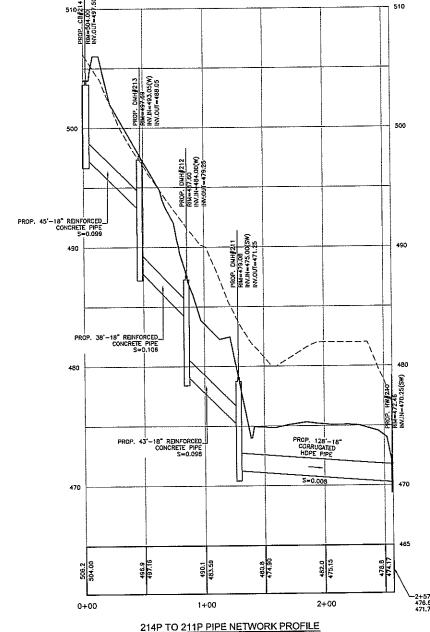

SCALE: 1" = 40' (HORZ.)

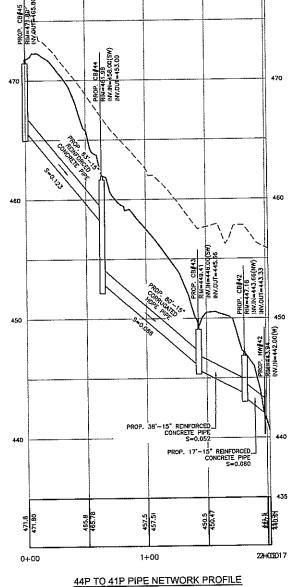

SCALE: 1" = 40' (HORZ.)

1" = 4" (VERT.)

CONSTRUCTION DETAILS

JENNESSTOWN MANOR MAP 7, LOTS 39 & 39-1

> ROUTE 103 WARNER, NEW HAMPSHIRE MERRIMACK COUNTY

> > OWNER/APPLICANT;


PEACOCK HILL ROAD, LLC 145 OLD TOWN ROAD WEARE, NH 03281 BK. 3829 PG. 2512


KEACH-NORDSTROM ASSOCIATES, INC.


Civil Engineering Land Surveying Landscape Architecture 10 Commerce Park North, Suita 3B, Bedford, NH 03110 Phone (603) 627-2881



		REVIS.	IONS		
No.	DATE		BY		
1	5/22/25	PER PB AND	AOT COMMENTS	AEW	
		 			
		 			
DATE: MARCH 25, 2025 SCALE: AS SH					
PRO.	ECT NO: 2	24-0307-1	SHEET 16 OF 16		
		1 5/22/25 DATE: MARCH 2	1 5/22/25 PER PB AND	1 5/22/25 PER PB AND AOT COMMENTS DATE: MARCH 25, 2025 SCALE: AS SH	

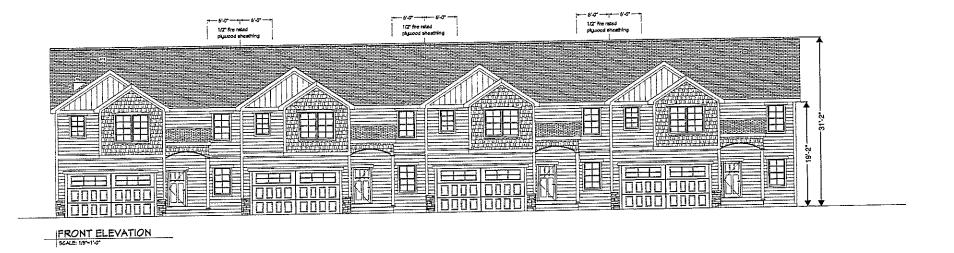

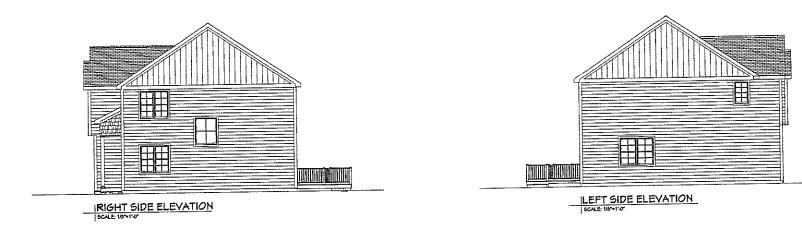

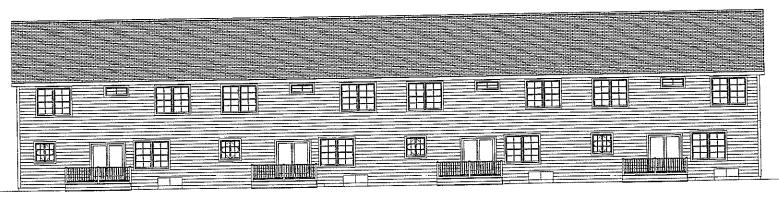

REAR ELEVATION

RESIDENTIAL DESIGN SOLUTIONS
BY LISA MELVIN, LLC
PO BOX 548 MONT VERNON, NH 03057
603-235-4246
LMELVIN548@GMAIL.COM

PREPARED FOR: 4 UNIT DWELLING


REVISIONS

ELEVATIONS

DATE: 1-26-2025
SCALE: AS NOTED
DRAWN BY: LAM
JOB NO.: FIT-2501

A-1

© COPYRIGHT 2024 RESIDENTIAL DESIGN

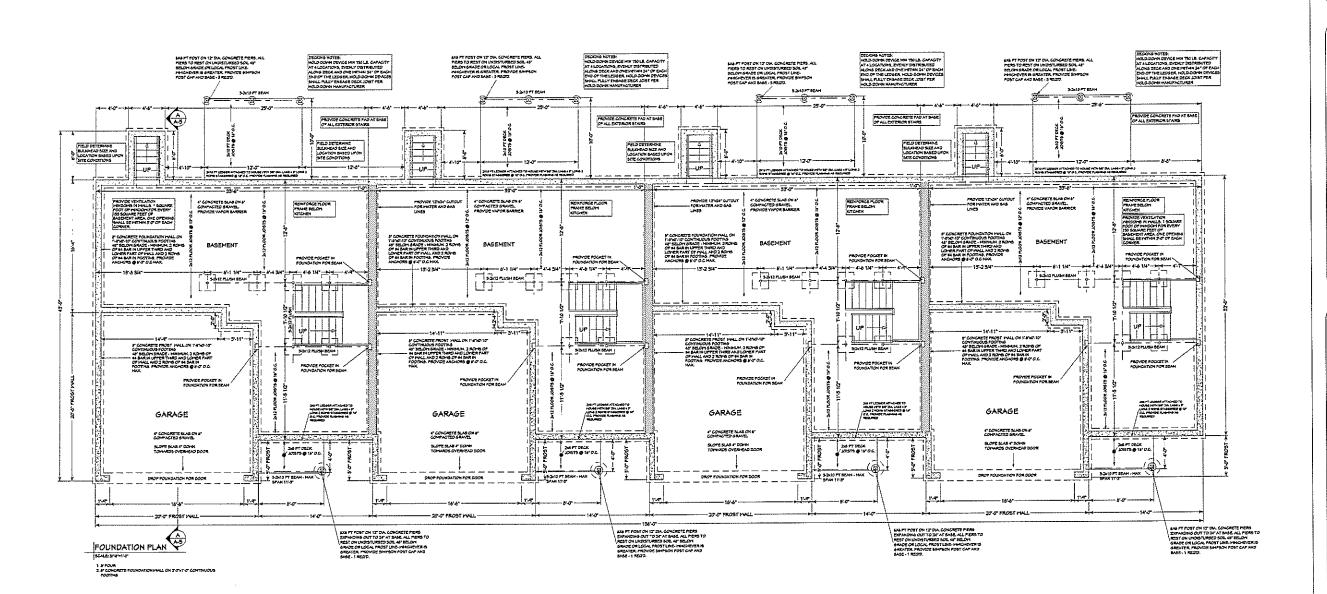

RESIDENTIAL DESIGN SOLUTIONS
BY LISA MELVIN, LLC
PO BOX 548 MONT VERNON, NH 03057
603-235-4246

LMELVIN548@6MAIL.COM

PREPARED FOR: 4 UNIT DWELLING


REVISIONS

FOUNDATION PLAN

DATE: 1-26-2025
SCALE: AS NOTED
DRAWN BY: LAM
JOB NO.: FIT-2501

A-2

C) COPYRIGHT 2024 RESIDENTIAL DESTI SOLUTIONS BY LM

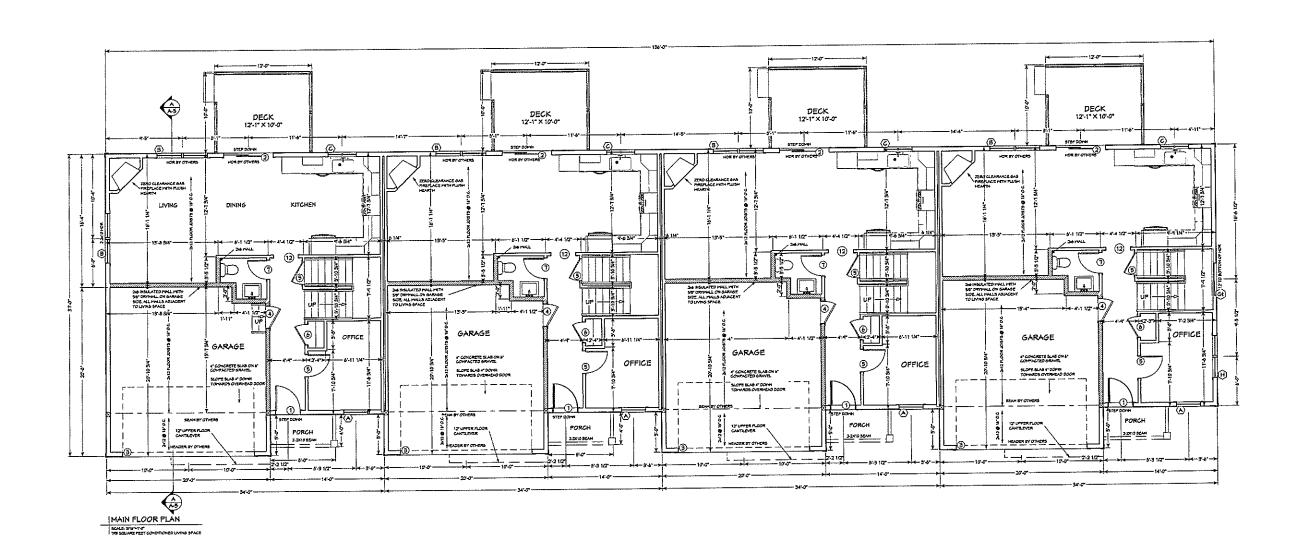

RESIDENTIAL DESIGN SOLUTIONS
BY LISA MELVIN, LLC
PO BOX 548 MONT VERNON, NH 03057
603-235-4246
LMELVIN548@GMAIL.COM 0

TO THE BEST OF MY RADMLEDGE THESE PLANS HAVE BEEN DRAWN COMPY WITH OWNERS AND OR BUILDERS SPECIFICATIONS. AND COMPLY WITH OWNERS AND OR BUILDERS SPECIFICATIONS. AND CHARLES MADE AFFER HAVES HAVE BEEN SIZED WILL BE ATHER EXPENSE AND RESPONSIBLE FOR THE CONTRACTOR. CONTRACTOR SHOWNERS AND SPECIFICATION. CONTRACTOR SHALL RELEASE AND CHARLES STORE THE COMPLEX OF ALL DRAWNERS AND SPECIFICATION. CORE. CONTRACTOR SHALL RELEASE AND ON ELECTROS IS ESSOURCED TO THE CORE AND SPECIFICATION OF ALL SHACKINGS AND STRUCTORS. AND SPECIFICATION SHALL SHACKING SEED SEED WITH TO AND SPECIFICATION. CONTRACTORS IS ESSOURCED TO ALL SHACKINGS AND STRUCTORS. THE SHALL SHACKING SEED SEED SHALL S

PREPARED FOR: 4 UNIT DWELLING


REVISIONS

MAIN FLOOR PLAN

DATE: 1-26-2025 SCALE: AS NOTED DRAWN BY: LAM JOB NO.: FIT-2501

A-3

© COPYRIGHT 2024 RESIDENTIAL DESIGN SOLUTIONS BY L.M.

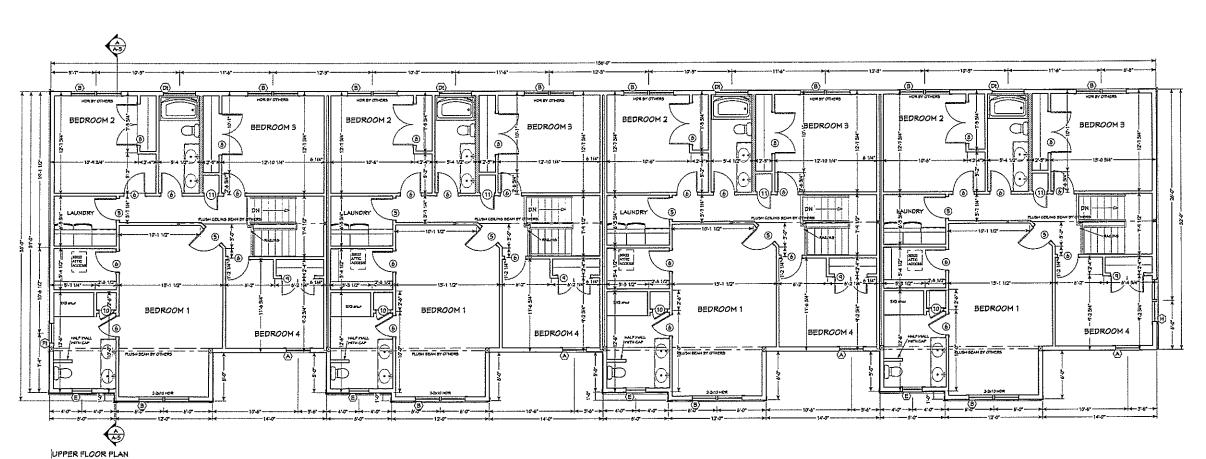

SCALE: STS-T-UT TOPS RELAKE FEET CONDITIONED LAYING SPACE 1. SOFTHATE HESSHIT 2. ALL ENTERIOR VINCOOM HEADERS TO BE 2.36 UNLESS OTHERS RESIDENTIAL DESIGN SOLUTIONS
BY LISA MELVIN, LLC
PO BOX 548 MONT VERNON, NH 03057
603-235-4246
LMELVIN548@GMAIL.COM

PREPARED FOR: 4 UNIT DWELLING

REVISIONS

FLOOR PLAN


UPPER


DATE: 1-26-2025
SCALE: AS NOTED
DRAWN BY: LAM

DRAWN BY: LAM JOB NO.: FIT-2501

A-4

© COPYRIGHT 2024
RESIDENTIAL DESIGN
SOLUTIONS BY L.M.

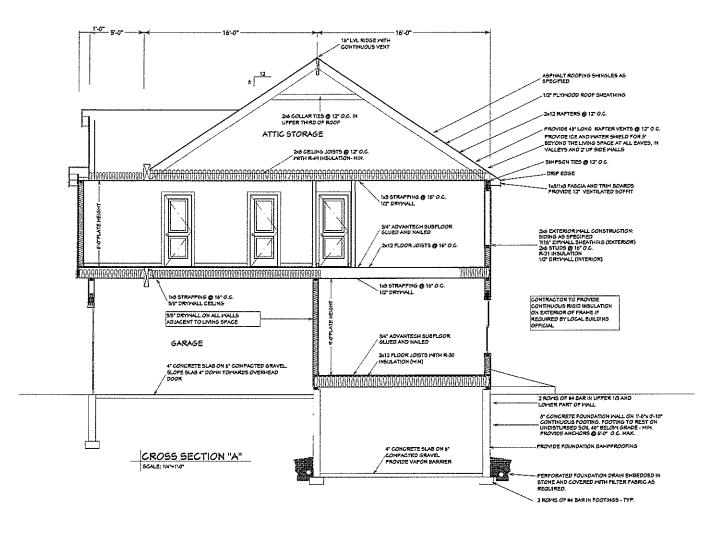

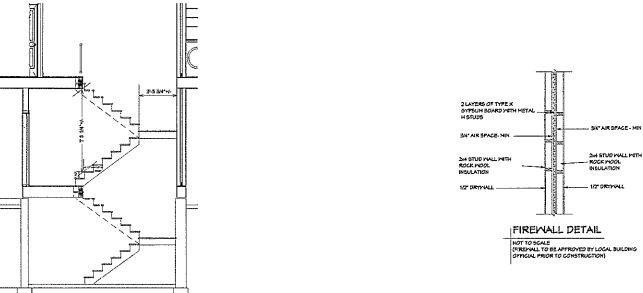


STAIR SECTION

NOTE: SILLS OF ALL WINDOWS TO BE 24" ABOVE PLOOR (MIN.) IF THEY ARE HIGHER THAN 6"O" ABOVE GRADE

MARK	QTY	R.O.	DESIGNATION	DESCRIPTION
$\langle A \rangle$	8	36"x60"+/-		DOUBLE HUNG - EGRESS
⟨B⟩	17	72"x60"+/-	•	MULLED DOUBLE HUNG- EGRESS
⟨८⟩	4	42"×42"+/-		DOUBLE CASEMENT
(Dt)	4	48"×18"+/-		AMNING - TEMPERED
(E)	4	30"x48"+/-		DOUBLE HUNG
⟨Ft⟩	1	30"x48"+/-		DOUBLE HUNG - TEMPERED
⟨Gt⟩	1	48"x60"+/-		FIXED - TEMPERED
(H)	2	60"x60"+/-		MULLED DOUBLE HUNG

MARK	QTY	SIZE	DESCRIPTION
(1)	4	3068	GLAZED ENTRY
(2)	4	6068	SLIDER
(3)	4	16'x8'	OVERHEAD GARAGE DOOR
(4)	4	2868	B-LABEL MV SELF CLOSING HINGES
5)	16	2868	INTERIOR
6 28 28		2668	INTERIOR
7	4	2468	INTERIOR
(3)	8	5068	INTERIOR DOUBLE
٩)	4	4068	INTERIOR DOUBLE
(10)	4	2068	INTERIOR
(11)	4	1868	INTERIOR
(12)	4	3066	CASED OPENING

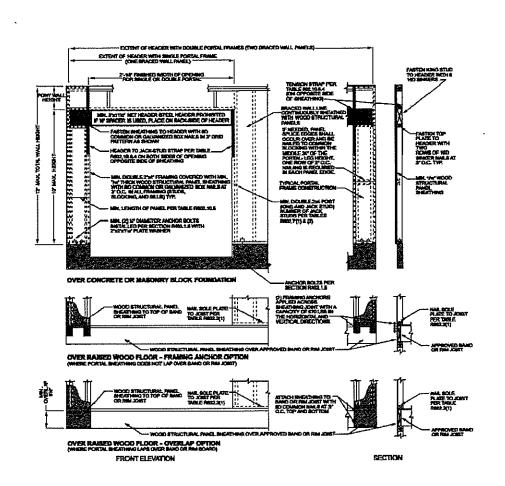

RESIDENTIAL DESIGN SOLUTIONS
BY LISA MELVIN, LLC
PO BOX 548 MONT VERNON, NH 03057
603-235-4246
LMELVIN548@GMAIL.COM

PREPARED FOR: 4 UNIT DWELLING 5ECTIONS AND DETAIL!

REVISIONS

DATE: 1-26-2025 SCALE: AS NOTED DRAWN BY: LAM JOB NO.: FIT-2501

A-5

© COPYRIGHT 2024 RESIDENTIAL DESIGN SOLUTIONS BY L.M.